


# **EXHIBIT LIST**

File Number	Appellant
SDAB 2025-005	SpeedPro Signs Fort McMurray

Legal Description	Civic Address
Unit 297, Plan 0220695	120 McTavish Crescent, Fort McMurray

Exhibit #	Description	Filing Date
	Subject Area Map	2025-08-15
1.	Notice of Appeal (3 pages)	2025-08-13
2.	Development Permit Refusal No. 2025-DP-00235 (2 pages)	2025-08-13
3.	Planner's Report (59 pages)	2025-10-09

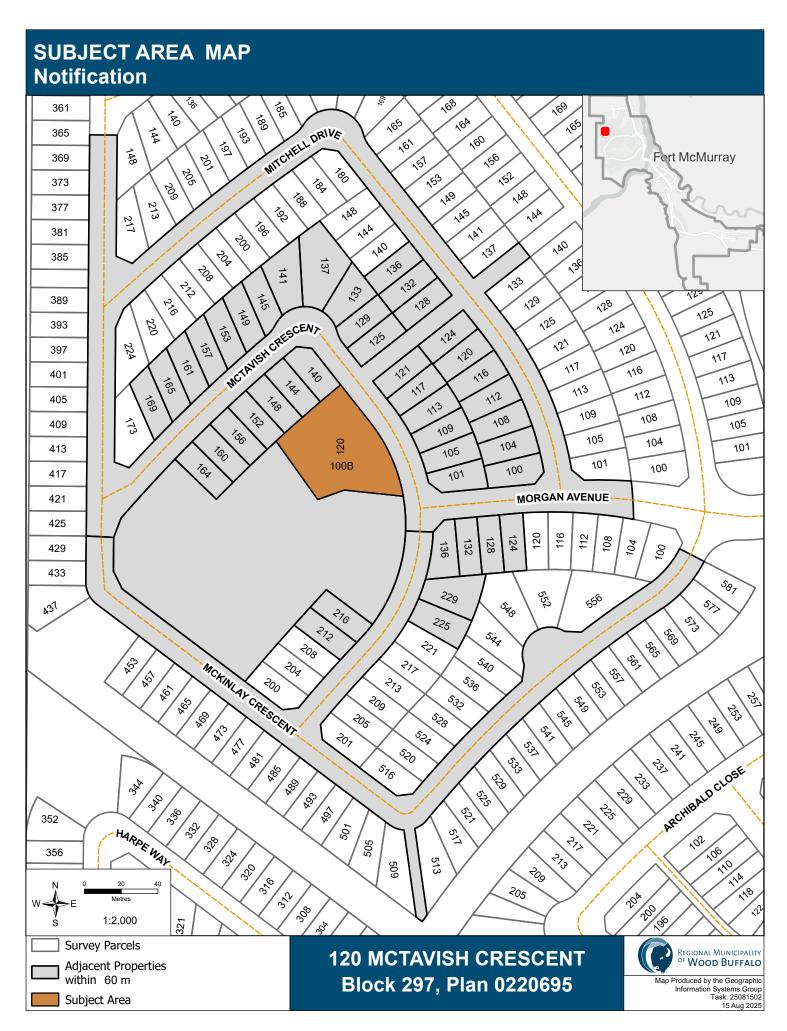



### SUBDIVISION AND DEVELOPMENT APPEAL BOARD **NOTICE OF APPEAL**

In accordance with Section 678 and 686 of the Municipal Government Act and the Regional Municipality of Wood Buffalo Land Use Bylaw 99/059, an appeal to the Subdivision and Development Appeal Board must be filed within the legislated time frame.

SDAB 2025-005 Received by the Subdivision and Development Appeal Board August 13, 2025

Section 1 – Pi	roperty Informat	ion					
Legal Land Description:(i.e. Lot, Block, Plan or ATS 1/4 Sec-Twp-Rng-Mer)							
Lot Unit	Block	Plan Condo		ATS			
297		022069	5				
Civic Address	C						
120 McTavish							
	t Number or type of Ord	er					
2025-DP-002	35						
	pellant Informat he appeal hearing the in		agent must p	roduce the con	npleted	and signed Age	ent Authorization Form.
Appellant Name (If t	he Appellant is a compa	ny, enter the com	plete legal na	me of the comp	pany)		
	igns Fort McMu	rray					
Agent <sup>1</sup> Name (if app	olicable)					erent) and posit	ion held
				Debbie	e Hah	ın	
Mailing Address			City/Town			Province	Postal Code
ATIA s. 20	0(1)						
Telephone Number	(Daytime) Altern	ate Telephone Nu	ımber	Email Addres	ss		
Section 3 – A	ppeal (Check One Bo	x Only) for multipl	e anneals voi	ı must suhmit a	another	Notice of Appe	al
Development Po		Subdivision A				e of Order	
☐ Approval		☐ Approval					
☐ Condition of Ap  X Refusal	pproval	☐ Condition of	Approval			lotice of Order	
I/We are the Applicant or Land Owner of the subject property							
I/We are a person affected by an order, decision or development permit							
Section 4 – Reasons for Appeal							
Section 678 and 686 Municipal Government Act require that the written Notice of Appeal must contain specific reasons for the appeal. In support of your appeal, you are requested to provide a full statement of the grounds and reasons of your appeal. You may include any photographs,							
drawings or plans for clarification.							
I/We hereby appeal the decision of the Approval Authority for the following reason(s):							
Please see attached							
						(Attach a s	eparate page if required)
PLEASE SEE REVERSE FOR IMPORTANT INFORMATION  ATIA s. 20(1)							
August 5, 202	5	01=	nature of An	llont/Agont			
Date Signature of Appellant/Agent							
If an Agent is repre	senting the property	owner, a letter is	s required fr	om the owner	r giving	g consent to a	property inspection.
Registered Owner:	I/We hereby ais	e permission to the	he Regional M	/Junicipality of \	Wood R	Suffaio to do a s	site inspection and take
		he property as neo	essary for the p	ourpose of this A			
		X	A IIA S. 20 Bim Ogunya Aug 8,				
			nature of Regi				
William we let	STANIST STATE OF THE STATE OF T	o do segon de San			7793		
Please return th	e completed form	and prescrib	ed filing fe	ee to:			
	n and Development Appe 001 Email: sdab@rmwb.		Jubilee Center	, 9909 Franklin	Avenue,	, Fort McMurray	AB T9H 2K4
D ( () (D )							

Protection of Privacy

The personal information you provide on this form is collected under the authority of section 4(c) of the Protection of Privacy Act. It will be used to process your appeal with the Subdivision and Development Appeal Board (SDAB). Your information will be disclosed in accordance with section 13(1) of the Protection of Privacy Act. If you have any questions regarding the collection or use of this personal information, please contact the Legislative Officer – SDAB, 7th Floor, 9909 Franklin Avenue, Fort McMurray, AB T9H 2K4, or call 780-788-2222.

10000000000000000000000000000000000000	作 电波 探示	For Office Use	Only	
Appeal #:	Fee:	Appeal Hearing Date:	Date Applicant Notified:	Date Appellant Notified:

<sup>1</sup> Agent — A person who acts for a Property Owner, Applicant, Appellant, and/or Affected/Adjacent Property Owner during the appeal hearing process or at a hearing before the Subdivision and Development Appeal Board.

### Section 4 - Reasons for Appeal

The property in question is a new commercial building that is allowed in that area because it is a daycare. The issue is to have signage on the building due to,

"The subject property is located within the RMH-1 – Modified Manufactured Home District, and in accordance with Section 8.3 of the amended Sign Regulations, fascia signs are not identified as either a permitted or discretionary use within this land use district."

It is important that signage is allowed on the building for not only identification for public knowledge and customer direction but also for ease in the event any emergency vehicles are called there.



# SUBDIVISION AND DEVELOPMENT APPEAL BOARD AGENT AUTHORIZATION

Section 1 - Principal Information Registered Property Owner(s) Name 2610740 Alberta Inc		Registered Owner(s) Bim Ogunye		SDAB 2025-005 Received by the Subdivision and Development		
Registered Address 117 Nicholson Drive		Fort N	AcMurray, All	berta, T9K	0Z6	Appeal Board August 13, 2025
Section 2 - Agent Informa	ation					2
Agent Name			Contact Name (if	different) and p	osition held	
SpeedPro Signs Fort Mc	Murray		Debbie Ha	hn		
Mailing Address	Ci	ty/Town		Province	Postal Code	
ATIA s. 20(1)						
Telephone Number	Alternate Telephone	Number	Email Address			
ATIA s. 20(1)						

### Section 4 – Acknowledgement and Certification

By signing below, I/We do hereby authorize the above noted agent to act solely on my/our behalf with respect to:

- I/We provide authority to the agent, as identified in section 2, to represent the registered owner(s) identified in section 1 to:
  - file an appeal/request for review on behalf of the registered owner(s) described on this form;
  - (b) discuss the issues or matters of the appeal/review with the municipality;
  - prepare and submit disclosure regarding the appeal/review; (c)
  - represent the registered owner(s) at hearings before the subdivision and development appeal board and
- 2. I understand that the registered owner continues to be subject to all provisions required by the Municipal Government Act and its attendant regulations and any authorization of an agent is not a substitute for any of those provisions.
- I understand that the registered owner is liable for any costs awarded against the agent by a subdivision and development 3. appeal board, or for any change in the permit or order that may result from a hearing.
- The agent has disclosed the qualifications, professional designations, certifications, or affiliations of the agent, if any, with 4. respect to the appeal.
- I may revoke authorization at any time in writing to the subdivision and development appeal board clerk. 5.

Bim Ogunye 08/08/2025 Bim Ogunye Signature of the Principal Printed name of the Signatory Person and Title Date (mm/dd/yyyy)

Signature:

im Oguny (Aug 8, 2025 10:49:22 MDT)

Email: director@kloriouskids.com

#### Protection of Privacy

The personal information you provide on this form is being collected under the authority of section 4(c) of the Protection of Privacy Act. The personal information is used to process your designation of an agent for appeals with the Subdivision and Development Appeals Board. If you have any questions about the collection and use of the personal information contact the Legislative Officer, 7th Floor 9909 Franklin Avenue, Fort McMurray AB T9H 2K4; or call 780.788.2222



DEVELOPMENT PERMIT: #2025-DP-00235

July 28, 2025



**Attention: Debbie Hahn** 

Dear Debbie Hahn,

RE: DEVELOPMENT PERMIT DECISION: Fascia Sign at 120 McTavish Crescent

Condominium Unit: 297, Plan: 0220695

Your application for a development permit at the above-mentioned location has been REFUSED by the Development Officer. The reasons for the refusal are outlined in the enclosed Development Permit Decision.

We are enclosing this Development Permit Decision, in duplicate, and request that you **PLEASE READ CAREFULLY.** 

Should you require further information, please contact the undersigned.

Yours truly,

The Regional Municipality of Wood Buffalo

Per: Phyllis Agyemang, Planner I

E: Phyllis.Agyemang@rmwb.ca T: 780-743-7084

Planning and Development Services

#### Attachments:

Development Permit #2025-DP-00235 REFUSAL Fascia Sign Notice of Appeal Application

J. W.



**DEVELOPMENT PERMIT:** #2025-DP-00235 REFUSAL

DATE: Monday, July 28, 2025 APPLICANT: Debbie Hahn

Civic Address: 120 McTavish Crescent

**Legal Address:** Condominium Unit: 297, Plan: 0220695 **DEVELOPMENT PERMIT REFUSED:** Fascia Sign

This Development was REFUSED by the Development Officer for the following reasons, in accordance with the Municipality's Land Use Bylaw No. 99/059 as amended in 25/003:

Section 8.3 – The permitted and discretionary uses for each sign type in residential districts.

The Land Use Bylaw does not identify fascia signs as either a permitted or discretionary use within the RMH-1 – Modified Manufactured Home District. As such, signage of this type is not allowed in this district.

Given that the proposed fascia sign does not comply with the Land Use Bylaw, and the Development Authority does not have the discretion to approve it, the application is hereby refused.

DATE OF DECISION: Friday, July 25, 2025



**Development Officer** 

#### IMPORTANT NOTE

- 1. Under the Municipal Government Amendment Act, this decision may be appealed within twenty-one (21) days after the day of the decision being posted.
- 2. An appeal shall contain a statement of the grounds of appeal and shall be delivered personally or by registered mail to reach the Secretary of the Subdivision and Development Appeal Board, 9909 Franklin Avenue, Fort McMurray, AB, T9H 2K4 within the prescribed period of twenty-one (21) days.
- **3.** Upon delivery of a Notice of Appeal, the appellant shall pay to the Regional Municipality of Wood Buffalo, where the appellant is the owner of the site, or his agent, a fee of \$500.00.

Refusal and further to this, I understand that I may have the Right of Appeal.					
Date	Applicant's Signature				

J. D.

### REPORT TO SUBDIVISION AND DEVELOPMENT APPEAL BOARD

File: SDAB 2025-005

Appellants: Debbie Hahn

Subject: Development Permit Refusal 2025-DP-00235

**Legal Description:** Condominium Unit 297, Plan 022 0695

Civic Address: 120 McTavish Crescent

**Land Use Designation:** RMH-1 – Modified Manufactured Home District

**Development Permit Application: 2025-DP-00235** 

**Development Permit Refusal Date: July 28, 2025** 

Appeal Application Date: August 14, 2025

### **Introduction**

1. This appeal stems from the refusal of Development Permit 2025-DP-00235, submitted for the installation of an illuminated fascia sign associated with an approved Childcare Facility at 120 McTavish Crescent, legally described as Condominium Unit 297, Plan 022 0695.

### **Chronology**

- 2. July 15, 2025 The Development Authority received an online application for the installation of a Fascia sign on a newly constructed building.
- 3. July 17, 2025 The application was assigned to a planner for review.
- 4. July 25, 2025 A secondary facie check was conducted, revealing that fascia signs are neither a permitted nor discretionary use in the RMH-1 Modified Manufactured Home District.
- 5. July 28, 2025 The Development Authority refused the development permit (Attachment 1) for the following reasons:
  - a. The Land Use Bylaw does not list fascia signs as either a permitted or discretionary use within the RMH-1 Modified Manufactured Home District.
  - b. The development authority interpreted that as, fascia signs are not permitted in the subject land use district.
  - c. Given that the proposed fascia sign does not comply with the Land Use Bylaw and the Development Authority does not have the discretion to issue an approval.

9909 Franklin Avenue, Fort McMurray, Alberta, Canada, T9H 2K4 www.rmwb.ca Anzac·Conklin·Draper·Fort Chipewyan·Fort Fitzgerald·Fort MacKay Fort McMurray·Gregoire Lake Estates·Janvier·Mariana Lake·Saprae Creek Estates As the application was refused at the secondary facie stage, no agency circulation was conducted.

### **Discussion**

- 6. The subject property is in the RMH-1 Modified Manufactured Home District. The purpose of this District is to provide for the development of manufactured home subdivisions which will allow for an attached garage in the Urban Service Area.
- 7. The proposed signage is associated with a Childcare Facility that was approved by the Development Authority on June 14, 2023 (Attachment 2).
- 8. The development Authority's approval of the childcare facility was appealed and subsequently upheld by the SDAB (SDAB 2023-003) on September 14, 2023 (Attachment 3).
- 9. Childcare Facility is a Discretionary Use in the RMH-1 District.
- 10. Section 8.3 of the Sign Bylaw (24/002) outlines permitted and discretionary sign types in all residential districts. Per section 8.3, no signs are permitted in the RMH-1 Modified Manufactured Home District.
- 11. Based on the information contained in the sign plan submitted for this application (Attachment 4), the proposed sign meets the sign provisions for Fascia Signs and would have been approved with standard conditions if located in a district where fascia signs are allowed.
- 12. To permit the proposed sign, a site-specific land use bylaw amendment would be required to include fascia signs as a discretionary use in the RMH-1 District.
- 13. The development authority is of the view that the proposed signage is consistent with the approved development of the land and will not negatively impact surrounding uses.

### **Recommendation:**

14. THAT the Subdivision and Development Appeal Board uphold the decision of the Development Authority.

### Rationale:

- 15. In accordance with the Municipality's Land Use Bylaw No. 99/059 as amended in 25/003:
  - a. Section 8.3 –The permitted and discretionary uses for each sign type in residential districts. Fascia Signs are not listed as either permitted or discretionary uses within RMH-1- District. As such, the proposed signage is not allowed in this District.
  - b. The development authority does not have the discretion to approve a use that is not contemplated for any land use district without a land use bylaw amendment.

2

### **Attachments:**

- 1. Refused Development Permit 2025-DP-00235
- 2. Development Permit Approval 2021-DP-00531
- 3. Notice of SDAB Decision (SDAB 2023-003)4. Proposed Sign Plan
- 5. Review Form
- 6. Notice of Appeal

# REPORT TO SUBDIVISION AND DEVELOPMENT APPEAL BOARD FILE#

Prepared By:	ATIA s. 20(1)	
	Phyllis Agyemang Planner/ Development Officer	October 8, 2025
Reviewed and Supported By:	ATIA s. 20(1)	
	Shailesh Makwana Supervisor	October 8, 2025
	Planning and Development Services	
Presented to:	Subdivision and Development Appeal Board	



DEVELOPMENT PERMIT: #2025-DP-00235

July 28, 2025

Debbie Hahn
ATIA s. 20(1)

**Attention: Debbie Hahn** 

Dear Debbie Hahn,

RE: DEVELOPMENT PERMIT DECISION: Fascia Sign at 120 McTavish Crescent

Condominium Unit: 297, Plan: 0220695

Your application for a development permit at the above-mentioned location has been REFUSED by the Development Officer. The reasons for the refusal are outlined in the enclosed Development Permit Decision.

We are enclosing this Development Permit Decision, in duplicate, and request that you **PLEASE READ CAREFULLY.** 

Should you require further information, please contact the undersigned.

Yours truly,

The Regional Municipality of Wood Buffalo

Per: Phyllis Agyemang, Planner I

E: Phyllis.Agyemang@rmwb.ca T: 780-743-7084

Planning and Development Services

#### Attachments:

Development Permit #2025-DP-00235 REFUSAL Fascia Sign Notice of Appeal Application

J. W.



**DEVELOPMENT PERMIT:** #2025-DP-00235 REFUSAL

DATE: Monday, July 28, 2025 APPLICANT: Debbie Hahn

Civic Address: 120 McTavish Crescent

**Legal Address:** Condominium Unit: 297, Plan: 0220695 **DEVELOPMENT PERMIT REFUSED:** Fascia Sign

This Development was REFUSED by the Development Officer for the following reasons, in accordance with the Municipality's Land Use Bylaw No. 99/059 as amended in 25/003:

Section 8.3 – The permitted and discretionary uses for each sign type in residential districts.

The Land Use Bylaw does not identify fascia signs as either a permitted or discretionary use within the RMH-1 – Modified Manufactured Home District. As such, signage of this type is not allowed in this district.

Given that the proposed fascia sign does not comply with the Land Use Bylaw, and the Development Authority does not have the discretion to approve it, the application is hereby refused.

DATE OF DECISION: Friday, July 25, 2025



#### IMPORTANT NOTE

- 1. Under the Municipal Government Amendment Act, this decision may be appealed within twenty-one (21) days after the day of the decision being posted.
- 2. An appeal shall contain a statement of the grounds of appeal and shall be delivered personally or by registered mail to reach the Secretary of the Subdivision and Development Appeal Board, 9909 Franklin Avenue, Fort McMurray, AB, T9H 2K4 within the prescribed period of twenty-one (21) days.
- **3.** Upon delivery of a Notice of Appeal, the appellant shall pay to the Regional Municipality of Wood Buffalo, where the appellant is the owner of the site, or his agent, a fee of \$500.00.

Refusal and further to this, I understand that I may have the Right of Appeal.					
Date	Applicant's Signature				



Permit Number 2021-DP-00531

June 14, 2023

**Applicant** 

Owner

KLORIOUS SERVICES INC.

ATIA s. 20(1)

TIA S. 20(1)

RE: Child Care Facility
120 MCTAVISH CRES

Lot: Block: 297 Plan: 0220695

Your application for a development permit at the above location has been approved by the Development Officer. This approval is subject to the conditions as outlined in the enclosed Development Permit.

# PLEASE READ PERMIT CONDITIONS CAREFULLY AND RETURN A SIGNED COPY TO OUR OFFICE.

This development permit shall expire and no longer be valid after one year from the date of decision of the permit if no construction has been initiated. Any other necessary permits shall be in place prior to commencement of any construction or occupancy. In the case of a change of use within an existing structure, where no significant construction of reconstruction is necessary, the applicant shall have the new use in operation within one year of the decision of the development permit.

### **IMPORTANT NOTE**

- 1. Under the Municipal Government Amendment Act, this approval may be appealed within twenty one (21) days after the day of decision being posted. Should this decision be appealed within twenty one (21) days after the Date of Decision, this permit shall not become effective until the Subdivision and Development Appeal Board has determined the appeal and the Permit may be modified or nullified thereby. Commencement of the approved Development prior to expiry of the appeal period is at your own risk.
- 2. An appeal shall contain statement of the grounds of appeal and shall be delivered personally or by registered mail so as to reach the Secretary of the Subdivision and Development Appeal Board, 9909 Franklin Avenue, Fort McMurray, AB T9H 2K4 within the prescribed time period of twenty one (21) days.
- 3. Upon delivery of Notice of Appeal, the appellant shall pay to the Regional Municipality of Wood Buffalo, where the appellant is the owner of the site, or his agent, a fee of \$500.00.

Compliance with other legislation - A person applying for, or in possession of a valid development permit is not relieved from full responsibility for ascertaining and complying with, or carrying out development in accordance with:

- a. the requirements of the Safety Codes Act, Environment Protection and Enhancement Act and Natural Resources Conservation Board Act;
- b. the requirements of any other Federal, Provincial, or Municipal statue, regulation code or standard; and
- c. the conditions of any caveat, covenant, easement or other instrument affecting a building or land. The Municipality is not responsible for not does the Municipality have any obligation whatsoever to determine what other legislation may apply to a development, nor monitor or enforce compliance with such legislation.

REGIONAL MUNICIPALITY OF WOOD BUFFALO Planning & Development Department per:



June 14, 2023

Lee-Anne Kumka
Planner III/Development Officer
Planning and Development Dept.
Land Services Branch
Regional Municipality of Wood Buffalo
Lee-Anne.Kumka@rmwb.ca

Date

9909 Franklin Avenue, Fort McMurray, Alberta, Canada, T9H 2K4 www.rmwb.ca
Anzac • Conklin • Draper • Fort Chipewyan • Fort Fitzgerald • Fort MacKay
Fort McMurray • Gregoire Lake Estates • Janvier • Mariana Lake • Saprae Creek Estates



# **Permit Number 2021-DP-00531**

Applicant: Adebimbola Ogunye Issued : June 14, 2023

# **Development Permit**

### **120 MCTAVISH CRES**

Lot	Block	Plan	Section	Township	Range	
	297	0220695	35	89	10	

## **Day Care Center (Child Care Facility)**

**Child Care Facility** 

Advertising Date June 22, 2023

- This development was approved by the Development Officer and is subject to the conditions attached to this permit.
- All conditions stated on this development permit must be complied with.
- You have one year from Date of Decision to commence construction. All appropriate building/mechanical permits must be applied for and issued. In the case of a change of use within an existing structure where no significant construction or reconstruction is necessary, the applicant shall have the new use in operation within one year of the decision of the development permit.

Regional Municipality of Wood Buffalo Planning & Development Department per:



**Issued :** June 14, 2023

Date

Lee-Anne Kumka
Planner III/Development Officer
Planning and Development Dept.
Land Services Branch
Regional Municipality of Wood Buffalo
Lee-Anne.Kumka@rmwb.ca

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Fort McMurray • Gregoire Lake Estates • Janvier • Mariana Lake • Saprae Creek Estates

Permit: 2021-DP-00531 120 MCTAVISH CRES Lot: Block: 297 Plan: 0220695

### **Advisory Notes:**

1 Any signage proposed for this development shall require a separate application and approval.

- The sump shall be installed so that discharge is as per the requirements of the Sewage Bylaw.
- The developer shall install all appropriate signage at access/egress locations in accordance with the requirements of the Engineering Department.
- 4 Site services shall be in accordance with the Engineering Standards of the Regional Municipality of Wood Buffalo Fort McMurray Urban Service Area and the standards set by the Franchise Utilities operating within the Fort McMurray Urban Service Area.
- A Utility Installation Permit is required from the developer and shall be obtained from Engineering Services Division prior to installing underground utilities.
- It shall be the developer's responsibility and expense to terminate, at the main, all sanitary and water services which will not be utilized in this development.
- A route permit shall be required for this development and shall be applied for through the Planning and Development Department.
- 8 Any damage to the streets, sidewalks, curbs or landscaped boulevards caused by this development shall be the full responsibility of the developer to restore.
- 9 All required Safety Code permits under the Safety Code Act in the: building, mechanical, electrical, gas, plumbing and private sewage disciplines must be obtained for this development. Please contact the Regional Municipality of Wood Buffalo Planning and Development Branch to obtain the required Safety Code permits or for information regarding these permits 780-799-8695.
- A Health Certificate may be required for this development. Please contact the Health Inspector for the necessary information.
- A Municipal Business License may be required for this development. Please contact the Licensing Enforcement Officer for information and an application, if required.
- The Alberta Fire Code applies in and around buildings existing or being constructed on a site. Complete project plans and specifications, construction fire safety plans, and fire related activities requiring Fire Prevention Permits shall be reviewed by the Fire Authority prior to the commencement of any work related thereto. Inquiries and permit applications shall be submitted to the Fire Authority.
- All Federal, Provincial and Municipal statutes and regulations shall be met, including the Alberta Building Code.
- -A Water Meter Permit will be required but because this is within private area (services are not Municipal), a Utility Connection Permit will not be required. Note that similar approvals will likely be required by the "condo board/management". Advisory notes:
  - -May want to verify existing connections with condo (ie. check record drawings). Proposed sizes, locations etc. may not match existing stubs.
  - -It is suggested to add a valve on the water connection.

- 15 1. A construction fire safety plan is required to be submitted and accepted prior to the commencement of construction activities.
  - 1b. An operational fire safety plan is required to be submitted and accepted prior to occupancy of the building.
  - 2. Ensure a Life Safety Plan is included at the building permit application phase, detailing information such as: travel distances to exits, fire separations and associated fire resistance ratings, design occupant loads, total building area, and the 3.2.2. building code major occupancy classification.
  - 3. A daycare facility with an occupant load more than 40 persons requires the installation of a fire alarm system.
  - 4. A building greater than 600 sq. m. in building area requires to be provided with access routes for fire department vehicles.
  - 5. Ensure emergency lighting is provided in conformance with the Building Code.
  - 6. Ensure exit signs are installed as required in conformance with the Building Code.
  - 7. Ensure fire extinguishers are installed in conformance with NFPA 10, "Standard for Portable Fire Extinguishers" 2013 edition.
  - 8. Confirm the type of cooking, including volume/frequency of cooking, that will occur on the premises so that it can be determined whether a commercial cooking equipment exhaust system and/or fire extinguishing system are required.
  - 9. There appears to be an interconnected floor space between the ground floor and the basement which would require the whole building to be fire sprinklered throughout in conformance with the National Building Code 2019 Alberta Edition.
- ATCO Transmission high pressure pipelines has no objections.

  Questions or concerns related to ATCO high pressure pipelines can be forwarded to hp.circulations@atco.com.
- Thank you for the opportunity to comment on the above referenced application for New Commercial Development Child Care Facility 2021 DP 00531. Alberta Health Services, Safe Healthy Environments (AHS SHE) reviews and provides comment on land use applications from a public health perspective.

  It is understood that this application proposes to construct a commercial childcare facility with a fenced play area. Documents submitted for this application, have been reviewed. AHS SHE has no objection to the application. However, it is imperative that the applicant abide by the Public Health Act and all applicable Regulations and Standards, including the Institutions Regulation AR 143/1981. The applicant must also ensure that all other Regulatory Agency concerns are addressed. The applicant must contact our office to complete the approval process for the facility and address/provide more information on the following:
  - Detailed plans for the kitchen (if food will be prepared and served at the facility) showing dimensions, floor finishes, etc.
  - Information on the proposed purpose/use for the basement space, including the kitchen
  - Submit a Social Care Facility Registration Form

I may be contacted by email or phone with any questions or concerns. Thank you.

### **Conditions:**

- This development is classified as a Child Care Facility and is a Discretionary Use -Planning Commission in the RMH – 1 Modified Manufactured Home District.
- Any temporary or auxiliary buildings/signs placed on site during construction shall be removed prior to occupancy.
- 3 Construction materials, including garbage, shall be stored so as not to create a nuisance to neighbouring properties.
- The garbage and waste material shall be stored in weather-proof and animal-proof containers and shall be visually screened in a manner compatible with the design and external materials of the principal buildings on the site. If a wood screen fence is used, it shall be constructed in accordance with drawing 10-301 of the Engineering Servicing Standards.
- The building location, orientation, capacity and/or use shall be as indicated on the approved drawings. Any changes to the approved plans shall be submitted to the Development Officer for further approval.
- The landscaping shall be completed as per the approved plans within one (1) year from the date of building occupancy or within two (2) years from the date of Development Permit issuance, whichever is sooner. Any changes to the approved Landscape Plans shall be submitted to the Development Officer for approval prior to the landscaping being installed.
- A minimum of 15 on-site parking stalls shall be provided as indicated on the approved plan. All parking stalls shall be hard surfaced with asphalt pavement, concrete or other similar paving material and shall be completed prior to the issuance of an Occupancy Permit. Should a seasonal allowance be required for paving the parking lot, the developer shall provide a written request for the seasonal allowance together with an automatically renewable and irrevocable letter of credit equal to 100 percent of the cost of paving the parking lot. A minimum of 2 of the required stalls shall be accessible parking stalls. These parking stalls shall be hard-surfaced, level, located close to an entrance, and shall be designated with the International Symbol of Access.
- A minimum of one loading space shall be provided for this development. Loading shall be designed and located so that all vehicles using those spaces can be parked and maneuvered entirely within the bounds of the site before moving onto adjacent streets or lands.
- All parking stalls shall be graded such that no slope in any direction is less than 0.5% and not more than 4%, to the satisfaction of the Development Officer. All soft landscaped areas shall have a minimum slope of 2% away from buildings.
- A final site grading plan shall be prepared to the satisfaction of the Engineering Department and shall be approved prior to occupancy of any buildings.
- The applicant shall enter into a Development Agreement with the Municipality to pay for the installation of public utilities, other than telecommunication systems or works, which are necessary to serve the development.
- Any excess fill must be deposited on a site approved by the Municipality. Please contact the Engineering Department and/or the Environmental Branch of the Public Works Department.
- Any and all easements required by the Municipality or any franchise utility as a result of this development shall be provided by the developer at no cost to the Municipality or any franchise utility and shall be registered on title by Utility Right-of-Way Plan.
- Should it be necessary to alter any on site Municipal or franchise utilities, all cost shall be borne by the developer.
- There shall be no unauthorized use of any adjoining Public Utility Lot or Reserve Land during the course of the approved development construction. The developer may apply to the Development Officer to utilize these lands.
- All on site lighting shall be located, oriented and shielded so as to restrict the unnecessary illumination of adjacent residential properties.

- Before any construction starts, the applicant shall ensure that the site is fully fenced, as per the approved fencing plan, in order to prevent any damage to Municipal infrastructure and landscaping surrounding the site, to ensure controlled and safe access and egress of the site, and to provide safe pedestrian access on and through any municipal lands adjacent to the site. The site access locations shall be established as per the fencing plan and will be maintained and operated to the satisfaction of the Development Authority. The fencing is to remain in place and in good working condition until all construction activities have ceased and a Full Development Completion Certificate has been issued.
- The applicant shall provide security in a form acceptable to the Municipality in the amount of \$88,627.35 as a guarantee for completion of the landscaping requirements. When the Municipality is satisfied that the site landscaping has been successfully installed and growing for a minimum of sixty (60) days and a Partial Development Completion Certificate has been issued, 50% of the Landscaping security can be returned. The following year once a Final Development Completion Certificate has been issued and the Landscaping passes a final Inspection the remainder of the security can be returned.
- Any required removal or modification of existing on-site underground storage tanks and the management of identified contaminants shall be undertaken to the satisfaction of the appropriate authorities prior to the construction of the approved development and all applicable permits received from the local Fire Authority.
- A Development Completion Certificate is required and shall be applied for by the applicant on completion of the conditions of development and prior to occupancy.
- A water meter permit may be required. Please contact Underground Services Division for details at 780-799-7493. 780-788-1456 ext. 5832
- A service connection permit may be required. Please apply at https://www.rmwb.ca/en/permits-and-development/applications-licences-and-permits.asp x.
- All required Safety Code permits under the Safety Code Act in the: building, mechanical, electrical, gas, plumbing and private sewage disciplines must be obtained for this development. Please contact the Regional Municipality of Wood Buffalo Planning and Development Branch to obtain the required Safety Code permits or for information regarding these permits 780-799-8695 or follow up on our permitting website: https://aca.woodbuffalo.ab.ca/citizenaccess/
- The applicant shall provide payment in a form acceptable to the Municipality in the amount of \$2,225.51 as Development Charges prior to issuance of the Development Permit.
- The applicant shall provide security in a form acceptable to the Municipality in the amount of \$20,000 as a guarantee for completion of the Engineering requirements.
- The applicant shall provide security in a form acceptable to the Municipality in the amount of \$10,450.00 as a guarantee for the installation and maintenance of the construction fencing.

2. DO NOT SCALE THE DRAWINGS. REPORT ERRORS, OMISSIONS AND DISCREPANCIES ON THE DRAWINGS DURING THE TENDER PERIOD FOR CLARIFICATION TO BEC LIMITED VIA EMAIL AT INFO@BECLIMITED.CA

3. THE CONTRACTOR AND OWNER ASSUME ALL LIABILITIES IN REGARDS TO THESE

4. THE GENERAL CONTRACTOR SHALL OBTAIN AND PAY FOR ALL PERMITS AND FEES ASSOCIATED WITH THE CONSTRUCTION OF THIS PROJECT. THESE INCLUDE, BUT ARE NOT LIMITED TO BUILDING PERMITS, INSURANCE, TEMPORARY POWER, WORKERS COMPENSATION, DEMOLITION COSTS ETC.

5. PROTECT AND MAINTAIN ALL EXISTING CONSTRUCTIONS AROUND SITE. KEEP STREET AND LANE REASONABLY CLEAN AND PROMPTLY REMOVE RUBBISH FROM THE BUILDING AND PROPERTY. THE CONTRACTOR SHALL CONFINE HIS APPARATUS STORAGE OF MATERIALS AND OPERATIONS OF HIS WORKFORCE TO AREAS DESIGNATED BY THE OWNER. ANY PORTIONS OF EXISTING CONSTRUCTION DAMAGED AND/OR DESTROYED DURING THE CONSTRUCTION AND THAT ARE NOT PART OF THIS WORK SHALL BE REPAIRED AND/OR REPLACED AT NO COST TO THE

6. STRUCTURAL DESIGN LOADS SHALL BE INDICATED ON THE STRUCTURAL DRAWINGS AND THE GC SHALL NOT EXCEED THESE LOADS

7. DUE TO ONSITE CONDITIONS, THE SPECIFICATIONS, PROCEDURES AND DIMENSIONS CAN VARY WITHIN REASONABLE LIMITS WHILE STILL MAINTAINING CODE REQUIREMENTS FOR RESIDENTIAL CONSTRUCTION. IN SUCH A CASE, THE GC MUST INFORM THE DESIGNER THAT SUCH A CHANGE IS BEING MADE AND ALLOW THE DESIGNER TO RECORD THIS ON THE DRAWINGS TO PREVENT FUTURE CONFLICT.

8. THE GRADE LINE SHOWN ON THE DRAWINGS IS A SUGGESTED LINE. THIS MUST BE VERIFIED ONSITE AND RECORDED AS THE ACTUAL GRADE.

9. ALL WINDOW AND DOOR SCHEDULES ARE APPROXIMATE ONLY AND SHALL BE VERIFIED BY THE WINDOW AND DOOR MANUFACTURERS.

10. WOOD CONSTRUCTION SHALL BE EXECUTED IN ACCORDANCE WITH SECTION 9.23 OF ABC, UNLESS OTHERWISE NOTED. ALL WOOD STUDS, COLUMNS, CRIPPLES
AND LINTELS SHALL BE #2 SPF GRADE OR BETTER UNLESS OTHERWISE NOTED.

**DAYCARE FACILITY** 

C/O KLORIOUS SERVICES INC

**5028 MACTAVISH CRESCENT** 

CONDOMINIUM PLAN: 0220695

FORT MCMURRAY, AB.

T9K 2N9, CANADA

**UNIT 297** 

- EXTERIOR WALLS SHALL BE 2 x 6 SPRUCE @ 19.2" O.C.
  EXTERIOR GARAGE WALLS SHALL BE 2 X 6 SPRUCE @ 19.2" O.C.
  INTERIOR WALLS SHALL BE 2 X 4 KILN DRIED SPRUCE @ 19.2" O.C.
- ALL REAMS TO BE ENGINEERED BY THE SUPPLIER
- WALL AND ROOF SHEATHING SHALL BE 1" OSB
- ENGINEERED FLOOR SYSTEM SHALL BE 3" OSB T&G SUB FLOOR. THE SUB FLOOR SHALL BE GLUED AND NAILED AS PER SUPPLIER'S INSTRUCTIONS REAR DECKS SHALL HAVE A NAILER BOARD FOR INSTALLATION.
- FRONT PORCH/VERANDA SHALL HAVE A 1  $^4_4$ " X 6 PRESSURE TREATED WOOD DECKING OVER 2 6 SPRUCE JOISTS WITH A LUMINUM RAILING. THE INTERIOR A CCESS STAIRS SHALL BE A HOUSED STRINGER, ROUTERED
- OUT 2 X 10 STUDS OR GLULAM EXPOSED ON BOTH SIDES.
- INTERIOR BASEMENT WALLS FROST WALLS SHALL BE 2 X 4 WOOD STUDS AT 24" O.C. AND FULL HEIGHT OF THE CONCRETE FOUNDATION WALL FRAMERS TO PROVIDE FULL BEARING SUPPORT TO ALL POSTS. LINTELS ETC.
- ALL WINDOW HEADERS TO BE A MINIMUM OF 2-PLY 2X10 #2 SPRUCE UNLESS NOTED OTHERWISE.
- ALL DIMENSIONAL LUMBER TO BE GRADED #2 SPF OR GREATER
- PROVIDE SOUND BLOCKING AT 24\* O.C. UNDER ALL PARTITION WALLS RUNNING PARALLEL TO FLOOR JOISTS.

#### 11. CONCRETE NOTES:

- ALL CONCRETE SHALL BE CSA TYPE HS (FORMERLY TYPE 50) 32 MPA LINLESS OTHERWISE STATED
- PILE DESIGN AND DEPTH SHALL BE AS PER THE ENGINEER FOUNDATION WALL 9 FT TOOL AND WILL REQUIRE REBAR IF REQUIRED BY
- THE ENGINEER
  THE FRONT WALKWAY SHALL BE CONSTRUCTED USING POURED CONCRETE AND SHALL NOT BE LESS THAN 4 FT. WIDE
- GARAGE SLAB TO BE FINISHED SMOOTH AND SLOPED 4" TOWARDS THE
- DAMP PROOFING REQUIRED BELOW SLAB
- ALL STEP FOOTINGS TO HAVE A MINIMUM OF 600MM RISE AND 600MM RUN.
- ALL CONCRETE FOUNDATION WALLS TO HAVE 6 HORIZONTAL ROWS OF REINFORCEMENT BARS
- ALL WINDOW WELLS TO BE A MINIMUM OF 30" DEEP OR HIGHER.

### 12 STAIR CONSTRUCTION

MIN. TREAD = 9.5" MIN. HEAD ROOM = 6' - 8" HANDRAIL HEIGHT = 32" to 36'

#### 13 ROOFING SIDING AND STONE

- ROOFING: COMES WITH A 25 YEAR WARRANTY, 3 TAB ASPHALT SHINGLES ANY SOFFIT PROJECTING INTO THE 1.2M SIDE SETBACK SHALL HAVE NO OPENINGS AND SHALL BE PROTECTED WITH MATERIALS AS OUTLINED IN THE ALBERTA BUILDING CODE GUIDELINES
- FAVES TROUGH SHALL BE 4" PRE-FINISHED ALLIMINUM
- VINYL SIDING SHALL BE AS PER PLAN AND WITH MAINTENANCE FREE CAPPING EXTERIOR STONE WORK SHALL CONFORM TO THE DRAWING AND AS OUTLINED IN THE ALBERTA BUILDING CODE
- PROVIDE ADEQUATE VENTILATION AND ACCESS TO ROOF SPACE.
  ALL ATTIC SPACE HATCHES SHALL BE WEATHER STRIPPED AND INSULATED
- WITH R-50 BATT INSULATION AND 6 MIL POLY VAPOUR BARRIER
- FLASHING IS REQUIRED FOR ALL HORIZONTAL JUNCTIONS AND EXTERIOR

#### GENERAL NOTES AND SPECIFICATIONS

#### HEATING

- THE HUMIDIFIER SHALL BE FLOW THROUGH/DRIP TYPE
  COLD AIR RETURNS AND HEAT REGISTERS SHALL BE WHITE AS PER THE SUPPLIER.
  HRV SIZING SHALL BE AS PER THE ALBERTA BUILDING CODE WITH THE MAIN
- CONTROLS MOUNTED BY THE MAIN THERMOSTAT WITH PUSH BUTTONS AND TIMERS IN BATHS ONLY
- EXHAUST VENTS IN ALL BATHROOMS SHALL BE 4
- THE FURNACE SHALL BE 96% EFFICIENT, 2 STAGE AND SIZE OF FURNACE SHALL BE DETERMINED BY HOUSE MODEL. AN HRV SHALL BE PROVIDED AND
- THE FINAL LOCATION OF COLD AIR RETURNS AND HEAT DUCTING SHALL BE DETERMINED ONSITE BY THE HEATING CONTRACTOR AND MAY BE ADJUSTED AS REQUIRED BY SITE CONDITIONS.
- SUPPLY VENTILATION IN ALL ROOMS: NATURAL OR MECHANICAL
- INSTALL RADON GAS VENTILATION ROUGH IN CENTERED BENEATH BASEMENT CONCRETE SLAB AND TERMINATED IN MECHANICAL ROOM. EXTERIOR PENETRATIONS THROUGH EXTERIOR MEMBRANES SHOULD HAVE
- SOME BACKING SUPPORT FOR POLY VAPOUR BARRIER.

#### 15 FLECTRICAL WORK:

- ALL CARBON MONOXIDE DETECTORS SHALL BE MOUNTED IN EACH ROOM ON EACH FLOOR.
- SMOKE DETECTORS SHALL BE MOUNTED IN ALL AREAS AS REQUIRED BY THE
- ELECTRICAL PANEL SHALL BE LOCATED IN THE BASEMENT AND ALL ELECTRICAL DISTRIBUTION WIRING SHALL BE COMPLETED FROM THE BASEMENT TO OTHER AREAS OF THE HOUSE.
- ALL ELECTRICAL WORK TO COMPLY WITH ALBERTA BUILDING CODE AND CANADIAN ELECTRICAL CODE REQUIREMENTS.

#### 16 INSULATION AND DRYWALL:

- ALL EXTERIOR HOUSE WALLS SHALL HAVE R-20 FIBERGLASS FRICTION FIT BATTS
- BASEMENT INSULATION SHALL BE R-12 FIBERGLASS BATT INSULATION. BETWEEN STUDS AND AT THE FULL HEIGHT OF BASEMENT FOUNDATION WORK. INSULATION SHALL BE R-20 FIBERGLASS FRICTION FIT BATTS AT ALL JOIST ENDS
- ALL CANTILEVER INSULATION SHALL BE R-28 ERICTION FIT BATTS ALL ATTIC INSULATION SHALL BE LOOSE FILL FIBERGLASS OR CELLULOSE (BLOWN). FIBERGLASS FRICTION FIT BATTS SHALL BE INSTALLED IN VAULTED
- ALL EXTERIOR WALLS SHALL HAVE A 6MM VAPOLIR BARRIER AND CONTINUOUS CAULKING AT ALL JOINTS AND AROUND ALL DOOR OPENINGS.
  ATTIC ACCESS AREAS SHALL HAVE FRICTION FIT BATT INSULATION.
- ALL INTERIOR DRYWALL SHALL BE 1/2 GYPSUM BOARD AND SCREWED AND NAILED WHERE APPLICABLE.
- ALL DRYWALL CEILINGS SHALL HAVE A \$ DRYWALL CEILING SURFACE SPLATTERED TEXTURE DESIGN THROUGHOUT THE HOME.
- GARAGE SHALL BE INSULATED WITH VAPOR BARRIER AND A MINIMUM OF 1" OF DRYWALL TO BE INSTALLED ON THE INTERIOR OF THE GARAGE
- FOR ALL SPACING GREATER THAN 400MM O.C, 15.9MM GYPSUM BOARD SHALL BE LISED FOR THE WORK
- ALL INSULATION SHALL BE PROTECTED FROM DAMAGE PRIOR TO

- A GAS BURNING FIREPLACE SHALL BE SUPPLIED AND INCLUDE A DIRECT VENT WITH 20,000 BTU GAS BURNER TECHNOLOGY, HEAT RATED CIRCULATING FIREBOX. IF THE FIREPLACE CANTILEVER IS 0.06M ABOVE GRADE, THEN THE LINDERSIDE MUST BE PROTECTED IN THE SAME WAY AS THE SOFFIT WITH NO OPENINGS AND SHALL BE PROTECTED WITH THE MATERIALS CONFORMING TO THE ALBERTA BUILDING CODE
- ELECTRICAL FIREPLACE CAN BE USED AND ARE OPTIONAL INSTEAD OF GAS

- ALL ROUGH IN PLUMBING TO BE VENTED AS PER THE PLUMBING CODE
- NO PLUMBING TO BE COMPLETED ON EXTERIOR WALLS. IF THE EXTERIOR WALL SIDE IS REQUIRED, AN ADDITIONAL FURRING WALL SHALL BE CONSTRUCTED AND PLUMBING RUN THROUGH THE INTERIOR WALL SECTION
- 19. ALL EXTERIOR EXPOSED STEEL TO BE PAINTED UNLESS NOTED OTHERWISE
- 20. VERIFY LOCATION OF ALL UNDERGROUND UTILITIES PRIOR TO COMMENCING CONCRETE FOUNDATION WORK
- ALL INTERIOR DOOR FRAMES TO BE LOCATED 4" FROM THE FACE OF THE WALL TO THE FACE OF THE DOOR FRAME UNLESS NOTED OTHERWISE
- 22. PROVIDE CONTINUOUS ROD AND CAULK JOINT AT ALL EXTERIOR WINDOWS, DOORS, CONTROL JOINTS AND OTHER LOCATIONS AS PER GOOD CONSTRUCTION
- 23. SEAL AIR/VAPOUR BARRIER TO PERIMETER OF ALL DOOR FRAMES AND WINDOW FRAMES.
- 24 ALL FIRE SEPARATIONS ARE TO EXTEND TO THE UNDERSIDE OF THE STRUCTURE OR ROOF ABOVE. ALL OPENINGS AND PENETRATIONS MUST BE PACKED AND SEALED WITH FIRE STOPPING MATERIAL. ALL MATERIALS MUST BE ULC LISTED. PRODUCT DATA TO BE APPROVED BY DESIGNER PRIOR TO INSTALLATION.
- 25. PROVIDE MINIMUM SLOPE AWAY FROM BUILDING FOR ALL GRADING.
- 26. PROVIDE MINIMUM 2% SLOPE FOR ALL EXTERIOR CONCRETE SLABS UNLESS NOTED OTHERWISE
- 27. ALL MATERIALS AND WORKMANSHIP SHALL CONFORM TO THE NATIONAL BUILDING CODE: NBC 2019 (AE). AS A MINIMUM AND AS INDICATED ON THESE DRAWINGS, THE STRINGENT TAKING PRECEDENCE.
- 28 CONFORM TO ALL MUNICIPAL BYLAWS BUILES AND REGULATIONS GOVERNING THE WORK. KEEP BUILDING AND PROPERTY CLEAN OF DEBRIS AND MATERIALS AT

ARCHITECTURAL  A0 COVER SHEET  A1 SITE PLAN  A1b AREA SURVEY PLAN  A1c SWEPT PATH ANALYSIS  A1d TYPICAL SITE DETAIL  A1e TEMP. SITE FENCING  A1f EGRESS PATH  A2 LANDSCAPING PLAN  A2b LANDSCAPING DETAIL  A3 MAIN FLOOR PLAN  A4 BASEMENT PLAN  A5 ROOF PLAN  A5B ROOF DETAIL  A6 E/W ELEVATION  A7 N/S ELEVATION  A8 WINDOW/DOOR SCHEDUL  A9 CROSS-SECTION DETAIL  A10 STAIR DETAIL  A11 ADDITIONAL DETAIL	DRAWING INDEX					
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A10 STAIR DETAIL						
A11 ADDITIONAL DETAIL						
	A11	ADDITIONAL DETAIL				

ARCHITECTURAL/LANDSCAPING **EFG ARCHITECTS** 

STRUCTURAL **BEC LIMITED** 

**MECHANICAL BEC LIMITED** 

**ELECTRICAL BEC LIMITED** 

CIVIL BY OTHERS

GEOTECHNICAL BY OTHERS

ENERGY EFFICIENCY BY OTHERS

MAIN FLOOR AREA: 7 498 SQ. FT BASEMENT AREA: 7,498 SQ.FT

ADDITIONAL CONSULTANTS

е

architects ind

9834-105 Street NV Edmonton, AB. T5K 1A6

BUILDER

BURHANI ENGINEERING AND CONSTRUCTION LTD 8735 53 AVENUE NW EDMONTON AB T6E 5G2 TEL: 587-754-0217 NFO@BECLIMITED.CA


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DAYCARE FACILITY 5028 MACTAVISH CRESCENT, FORT MCMURRAY, AB.

DRAWING TITLE

COVER SHEET

MARCH 20 2023 BEC-217 Scale 3 - 1'-0"

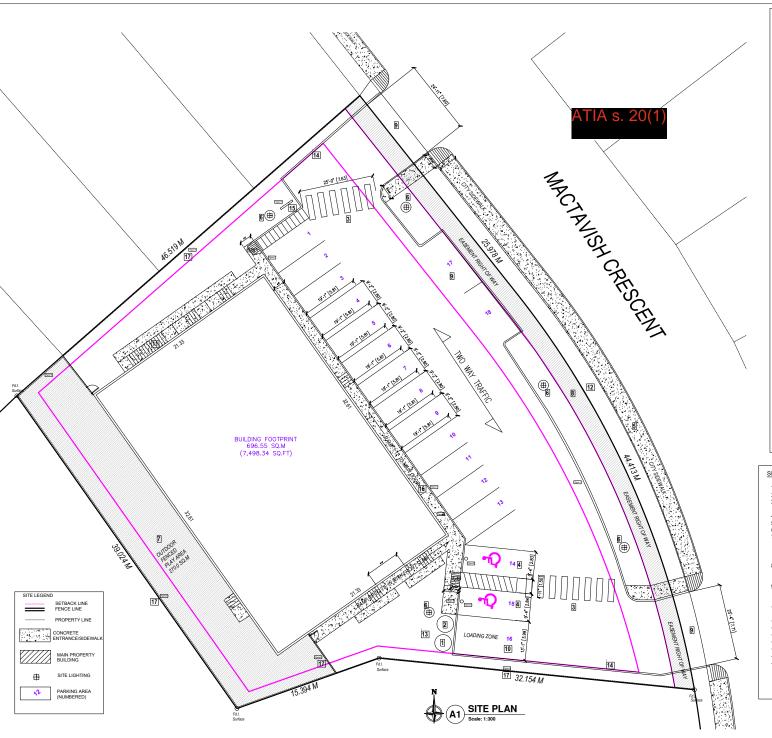

PROJECT INFORMATION AND DESCRIPTION:

LEGAL DESCRIPTION: CONDOMINIUM PLAN: 0220695, UNIT 297

MUNICIPAL ADDRESS: 5028 MACTAVISH CRESCENT, FORT MCMURRAY

ZONING: RMH-1: MODIFIED MANUFACTURED HOME DISTRICT

8,092.05 M2 (26,550 SQ.FT) AREA OF LOT:

SPRINKLERED: NΩ

PRINCIPAL BUILDING AREA: 7,498.34 SQ. FT (696.55 SQ.M) SITE COVERAGE: MAX. BUILDING HEIGHT: 696.55 / 8,092.05 = 8.61% 6.0M

MAX. LOT COVERAGE: MIN. SOFT LANDSCAPING: SETBACKS:

REAR: 2.0M SIDE YARD: 1 2M

GROSS BUILDING AREA:

MAIN FLOOR: 7,498.34 SQ.FT BASEMENT: 7,498.34 SQ.FT

18, 2 ACCESSIBLE STALLS PARKING AVAILABLE:

BICYLE STALLS: 6 STALLS ONSITE VEHICLE LOADING: 1 STALL

BUILDING CODE ANALYSIS:

PROPOSED LISES: GROUP A. DIVISION 2. DAYCARE FACILITY

BUILDING OCCUPANCY CLASS: GROUP A, DIVISION 2, DAYCARE FACILITY SECTION 3.2.2.25: GROUP A, DIVISION 2,

UPTO 2 STOREYS 1 STOREY MAXIMUM AREA - 1,600M2 FACING 1

1 STOREY MAXIMUM AREA - 1,800M2 FACING 1 STREET. COMBUSTIBLE OR NON-COMBUSTIBLE CONSTRUCTION IS PERMITTED ROOF ASSEMBLIES SHALL HAVE A 45MIN FIRE

LOAD BEARING WALLS, COLUMNS SHALL HAVE A 45MIN FIRE RATING

MAX. OCCUPANT LOAD; CHILDREN + STAFF: 166 PERSONS

SEPARATION OF OCCUPANCIES

NOT REQUIRED

EGRESS DOORWAYS:

A MINIMUM OF 2 EGRESS DOORWAYS LOCATED SO THAT ONE DOORWAY COULD PROVIDE EGRESS FROM THE SUITE IF THE OTHER DOORWAY BECOMES INACCESSIBLE TO THE OCCUPANTS DUE TO A FIRE WHICH ORIGINATES IN THE SUITE. SHALL TO A FIRE WHICH ORIGINALES IN THE SOTIE, SHALL BE PROVIDED FOR EVERY SUITE WITH OCCUPANTS MORE THAN 80, TRAVEL DISTANCE IS MORE THAN 25M AND THE AREA OF THE SUITE IS MORE THAN 600M2.

EVERY FLOOR AREA INTENDED FOR OCCUPANCY

SHALL HAVE AT LEAST 2 EXITS

EXIT CORRIDOR/PASSAGEWAY: 1.1M RAMPS: 1.1M STAIRS: 0.9M

DOORWAYS: 0.8M

POWER OPERATOR: REQUIRED ON MAIN ENTRANCE AND VESTIBULE

#### SITE KEY NOTES:

MIN. NO. OF EXITS:

- MOLOK CLASSIC GARBAGE BINS: 5M3 MOLOK CLASSIC RECYCLE BINS: 5M3
- PARKING LOT CROSS WALK LOCATION: ACCESS TO GARBAGE
- BARRIER FREE PARKING LOCATIONS: 2 STALLS.
   EXISTING MUNICIPAL SIDEWALK ON FRONT OF PROPERTY.
- EXTERIOR LIGHTING POSTS.
  SOFT LANDSCAPED AREA AT REAR OF BUILDING: USED FOR FENCED OUTDOOR DAYCARE PLAYGROUND FACILITY. TOTAL AREA OF PLAYSPACE PROVIDED: 285 SQ.M.
- REFER TO FENCE SPECIFICATIONS.

  2.0M EASEMENT: NO CONSTRUCTION IN SPACE. REFER TO RESTRICTIVE COVENANT 022454362 FOR ADDITIONAL INFORMATION.
- FRONT ENTRANCES TO PARKING AREA: 2 ENTRANCES AT NORTH AND SOUTH OF PROPERTY. TWO WAY TRAFFIC WITH
- 7.0M WIDTH AS PER ENGINEERING SERVICING STANDARD.

  10. 20 MINUTE LOADING ZONE AT SOUTH EAST SECTION OF BUILDING: PARKING SPOT 1.
- 11 SIDE BASEMENT ENTRANCE
- 12. MUNICIPAL GRASSED AREA
- 13. FENCED GARBAGE ENCLOSURE
- 14. SIDE CURBS AT PROPERTY SIDE SETBACK 15. BICYCLE RACK
- 16. BARRIER FREE RAMP TO MAIN ENTRANCE OF BUILDING.
- PROPERTY SHALL BE FENCED FULLY AS PER MUNICIPAL REQUIREMENTS
  - TOTAL PERIMETER FENCING: 133.091M ADDITIONAL FENCING FOR DAYCARE: 9.957M



Edmonton, AB. T5K 1A6

BUILDER

MAIN FLOOR AREA: 7,498 SQ. FT BASEMENT AREA: 7 498 SQ FT





DEDMIT STAMP



DAYCARE FACILITY 5028 MACTAVISH CRESCENT, FORT MCMURRAY, AB.

DRAWING TITLE

SITE PLAN

Date MARCH 20, 2023 Scale 1:300



ZONING REGULATIONS:

MAXIMUM HEIGHT OF BUILDING: 6.0M FOR FLAT/GAMBREL/MANSARD ROOFS MAXIMUM FLOOR AREA RATIO: NOT REQUIRED

SETBACK REQUIREMENTS: THE FRONT SETBACK: 6.0M SIDE SETBACK: 1.2M REAR SETBACK: 2.0M

PARKING/LOADING/STORAGE OR TRASH COLLECTION MAY BE PERMITTED WITHIN THE SIDE SETBACK PROVIDED THERE IS 1.5M OF SOFT LANDSCAPING WITHIN THE SETBACK AND ALL AREAS ARE SCREENED FROM ADJACENT VIEW.

architects inc.

9834-105 Street NW
Edmonton, AB. T5K 1A6

BUILDER

MAIN FLOOR AREA: 7,498 SQ. FT BASEMENT AREA: 7,498 SQ.FT

3 2024-6-10 SIMED FOR PERMITS MK.
2 2024-1-30 DIVINER REVIEW AG.
1 2024-1-310 DIVINER REVIEW MK.
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THIS DRAWNIG AND THE INFORMATION CONTAINED HEREIN IS THE BOOLEY FOR THE CONSTRUCTION OF THE PROJECT. THE STRUMME SHALL NOT HE CONSTRUCTION OF THE PROJECT. THE STRUMME SHALL NOT HE REPOOLED COPED OF DUE TO MAKE OF THE FOR ANY PURPOSE DECEMBER THE WORTH PROJECT OF THE DRAWNING HEREIN OF THE PROJECT OF THE PROJECT OF THE DRESSORE PROJECT OF THE PROJECT OF CONSTRUCTION, THE DESCRIPT OWNERSORS AND THE STRUMME OF CONSTRUCTION, THE DESCRIPT OWNERSORS AND THE STRUMME OF THE PROVIDED TO THE DRESSORE AND THE STRUMME OF THE PROVIDED TO THE SECRIPCE OF THE THE PROVIDED TO THE DESCRIPCE TO THE THE PROVIDED TO THE SECRIPCE TO THE SECRIPCE THE SEC

PROJECT

DAYCARE FACILITY 5028 MACTAVISH CRESCENT, FORT MCMURRAY, AB.


DRAWING TITLE

AREA PLAN

Checked by A.G.

A1b | REV 8

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ADDITIONAL CONSULTANTS e f architects inc 9834-105 Street NW

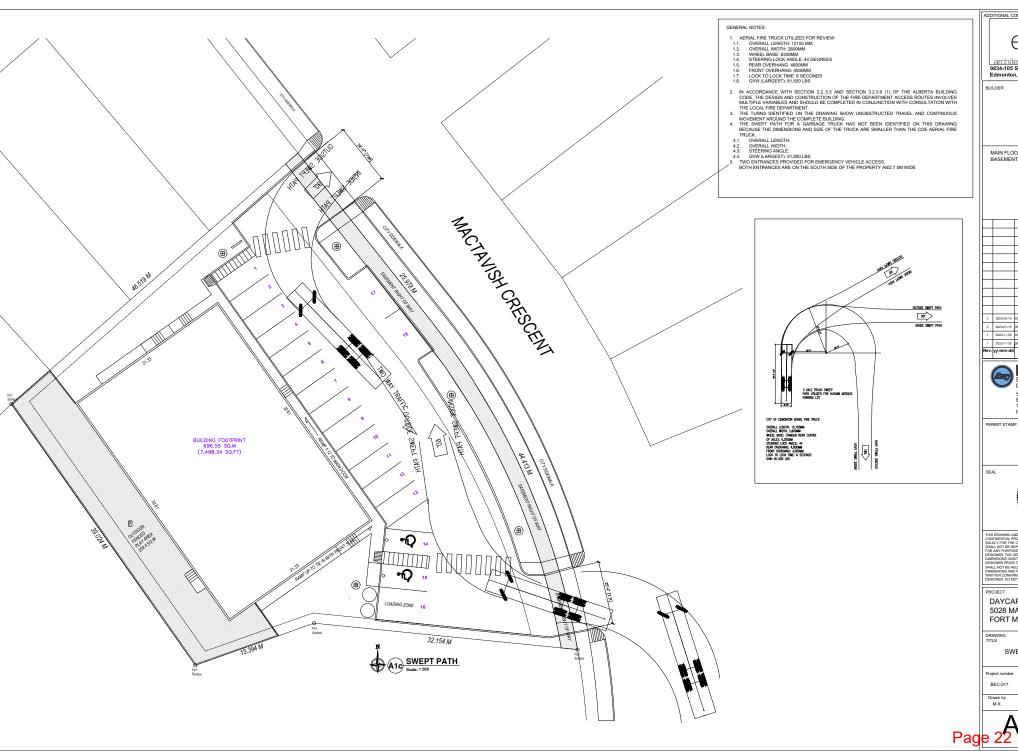Edmonton, AB, T5K 1A6

MAIN FLOOR AREA: 7,498 SQ. FT BASEMENT AREA: 7 498 SO ET

2 2023-01-15 DESIGN UPDATE - DP REVIEW





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DAYCARE FACILITY 5028 MACTAVISH CRESCENT, FORT MCMURRAY, AB.

SWEPT PATH ANALYSIS

Date MARCH 10, 2023 Scale 1:300

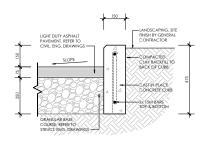


FIGURE 1: TYPICAL CURB DETAIL

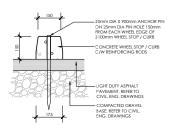


FIGURE 2: TYPICAL WHEEL STOP DETAIL

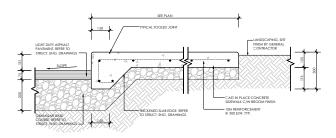


FIGURE 3: TYPICAL SIDEWALK CURB DETAIL

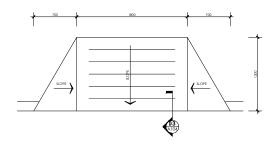


FIGURE 4: TYPICAL DROP-CURB DETAIL

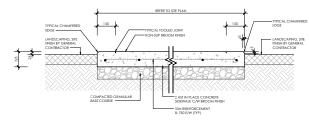


FIGURE 5: TYPICAL SIDECURB DETAIL

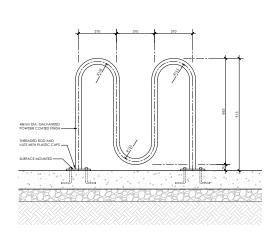


FIGURE 6: TYPICAL BICYCLE RACK DETAIL

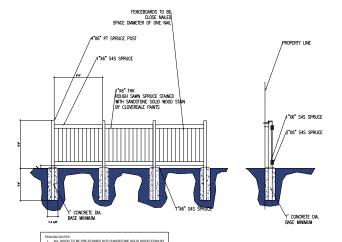




FIGURE 7: TYPICAL FENCING DETAIL

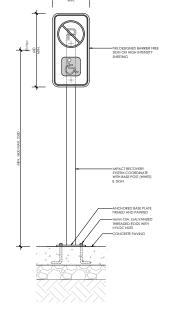


FIGURE 8: TYPICAL BARRIER FREE PARKING SIGN DETAIL



Edmonton, AB. T5K 1A6

BUILDER

MAIN FLOOR AREA: 7,498 SQ. FT BASEMENT AREA: 7,498 SQ.FT





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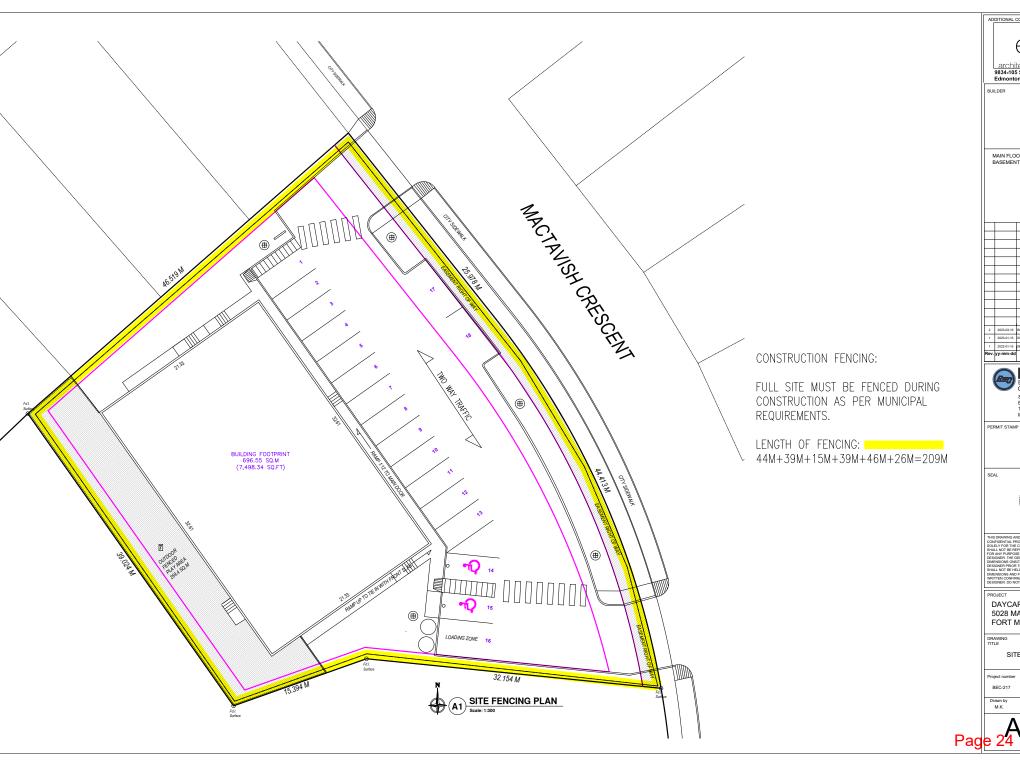
DAYCARE FACILITY 5028 MACTAVISH CRESCENT, FORT MCMURRAY, AB.

DRAWING TITLE

ADDITIONAL DETAIL

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ADDITIONAL CONSULTANTS architects inc. 9834-105 Street NW Edmonton, AB. T5K 1A6

MAIN FLOOR AREA: 7,498 SQ. FT BASEMENT AREA: 7,498 SQ.FT


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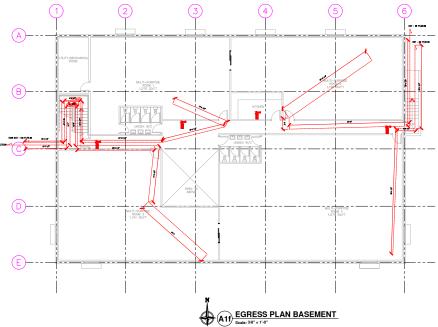


DAYCARE FACILITY 5028 MACTAVISH CRESCENT, FORT MCMURRAY, AB.

SITE FENCING (TEMPORARY)

Project number	Date MARCH 10, 2023		
BEC-217	Scale NOT TO SCALE		
Drawn by M.K.	Checked by A.G.		



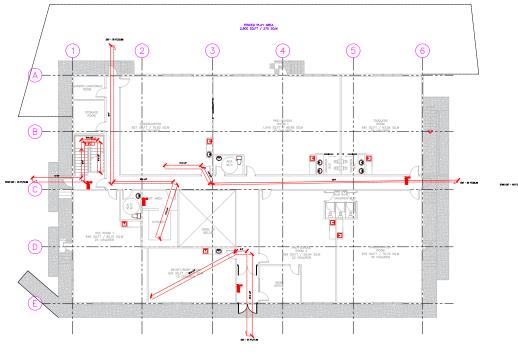



### TRAVEL DISTANCE AND ACCESS TO EXITS:

- 1. EXIT DISTANCES SHALL NOT EXCEED 30M FROM ANY POINT AS PER 3.4.2.5 (F) OF NBCC
- 2. FIRE EXITS IN OPEN SPACES ACCEPTABLE IN SINGLE STOREY STRUCTURES AND AS LONG AS DISTANCE TO EXIT IS LESS THAN 15M.
  3. GENERAL CONTRACTOR MUST INSTALL RATED DOORS WHERE REQUIRED.





MAIN FLOOR AREA: 7,498 SQ. FT BASEMENT AREA: 7.498 SQ.FT



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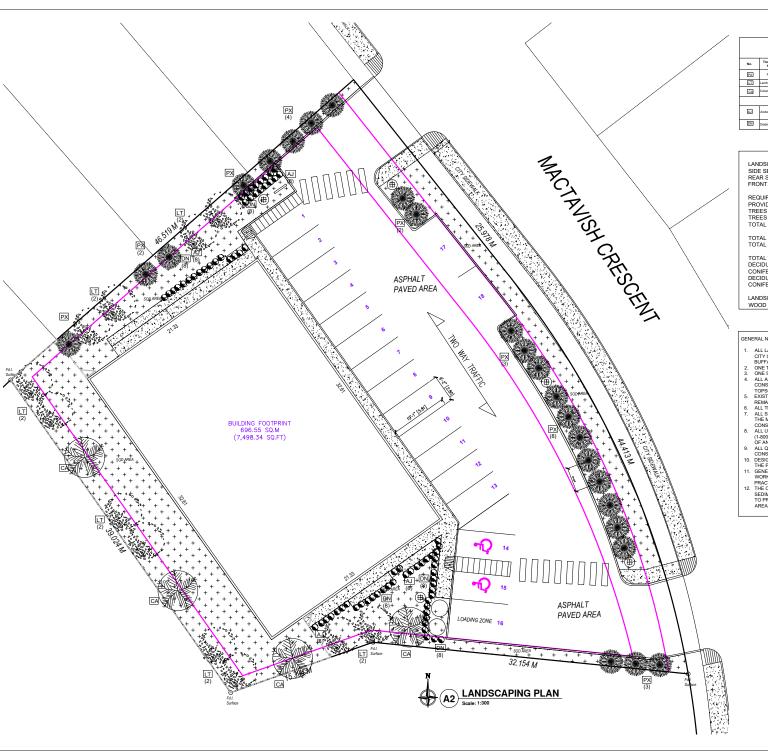


DAYCARE FACILITY 5028 MACTAVISH CRESCENT. FORT MCMURRAY, AB.

DRAWING TITLE

SITE FENCING (TEMPORARY)

Date MARCH 10, 2023 Scale NOT TO SCALE





LANDSCAPING CALCULATIONS: SIDE SETBACKS: 1.2M REAR SETBACK: 2.0M FRONT SETBACK: 6.0M

REQUIRED LANDSCAPED SPACE: 30% OF 2,466.33 SQ.M = 739.9 SQ.M PROVIDED LANDSCAPED SPACE: 754.3 SQ.M TREES REQUIRED FOR LANDSCAPED AREA: 739.9/25 = 30 TREES TREES REQUIRED FOR PARKING: 18/5 = 4 TREES
TOTAL NO. SHRUBS REQUIRED (YARD): 739.9/25 = 30 SHRUBS

TOTAL TREES REQUIRED: 34 TREES TOTAL SHRUBS REQUIRED: 30 SHRUBS

TOTAL TREE AND SHRUB COUNT PROVIDED: DECIDUOUS TREES: 28 CONIFEROUS TREES: 12 DECIDUOUS SHRUBS: 40 CONIFEROUS SHRUBS: 32

LANDSCAPING PLAN ACCEPTABLE IN ACCORDANCE WITH WOOD BUFFALO LAND USE BYLAW.

#### GENERAL NOTES:

- ALL LANDSCAPING AND PLANTING TO BE COMPLETED IN ACCORDANCE WITH CITY OF FORT MCMURRAY PLANTING GUIDELINES AS SET OUT IN THE WOOD BUFFALO ZONING BYLAW.
   ONE TREE REQUIRED FOR 25M2 OF LANDSCAPED AREA
   ONE SHRUE REQUIRED FOR 25M2 OF LANDSCAPED AREA
   ALL AREAS IN TOWN OF FORT MCMURRAY BOULEVARDS, DAMAGED DURING CONSTRUCTION TO RECEIVE SOO ON 150MM DEPTH COMPACTED CLASS B
   TOYOUT TYPICAL.
   SOURCE AND A CONTROL OF THE CONTR

- EXISTING TREES ALONG EDGE OF ROADWAY OR IN ANY OTHER LOCATION TO REMAIN IN PLOCET TO BE REMOVED FOR CONSTRUCTION.

  ALL NEEDS ON PROPERTY TO BE PLANTED ON THE GROUND ON MULCH BED. THE MULCH BED SHALL BE A MINIMUM OF 2 FEET IN DEPTH AS PER GOOD CONSTRUCTION PRACTICE.

  ALL UTILITIES SHALL BE CONFIRMED BY CALLING ALBERTA ONE CALL (1-800-242-3447) AND ALL UTILITIES SHALL BE MARKED OUT PRIOR TO THE START OF ANY CONSTRUCTION (DISSORRIBED AND NON-BUSSCRIBED UTILITIES).


- OF ANY CONSTRUCTION (SUBSCRIEDD AND NON-SUBSCRIEDD UTILITIES)

  ALL QUANTIES SHALL BE VERIFIED PRIOR TO THE START OF THE START OF THE ATER OF THE START OF THE CONSTRUCTION AND DESIGNAEROWNER NOTHERD INCESS OF DISCREPANCIES,

  DESIGN ERWINGOS SHALL BE ONSITE AT ALL TIMES FOR CONSTRUCTION OF

  11. GENERAL CONTRACTOR IS RESPONSIBLE FOR MAINTAINING A CLEAN AND SAFE WORKSTE AT ALL TIMES IN ACCORDANCE WITH GOOD CONSTRUCTION PRACTICE AND OSHA REQUIREMENT.

  2. THE CONTRACTOR SHALL BE RESPONSIBLE FOR EROSION CONTROL AND SEDMENTATION CONTROL AND SHALL BENGET THAT LEFFORTS AND SEDMENT AND

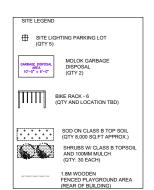



Edmonton, AB. T5K 1A6

MAIN FLOOR AREA: 7 498 SOLET BASEMENT AREA: 7,498 SQ.FT





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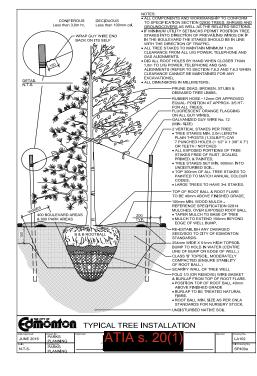



DAYCARE FACILITY 5028 MACTAVISH CRESCENT, FORT MCMURRAY, AB.


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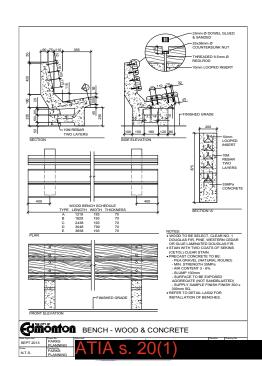
LANDSCAPING


Date MARCH 20, 2023 BEC-217 Scale 3 - 1'-0"





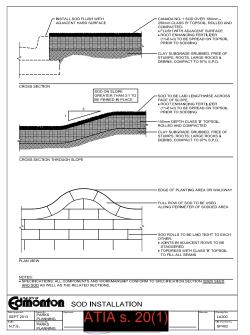

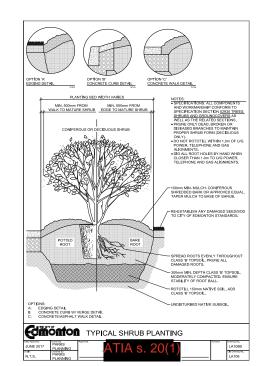

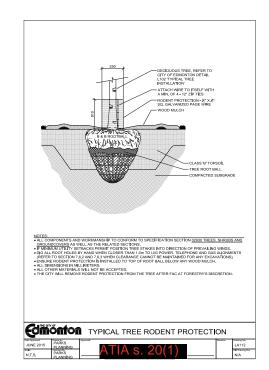

ADDITIONAL CONSULTANTS е

9834-105 Street NW

BUILDER

MAIN FLOOR AREA: 7 498 SQ. FT. BASEMENT AREA: 7,498 SQ.FT

2022-11-30	ISSUED FOR PERMITS OWNER REVIEW DEVELOPMENT PERMIT REVIEW Revision /Drawing Issue	AG AG MK
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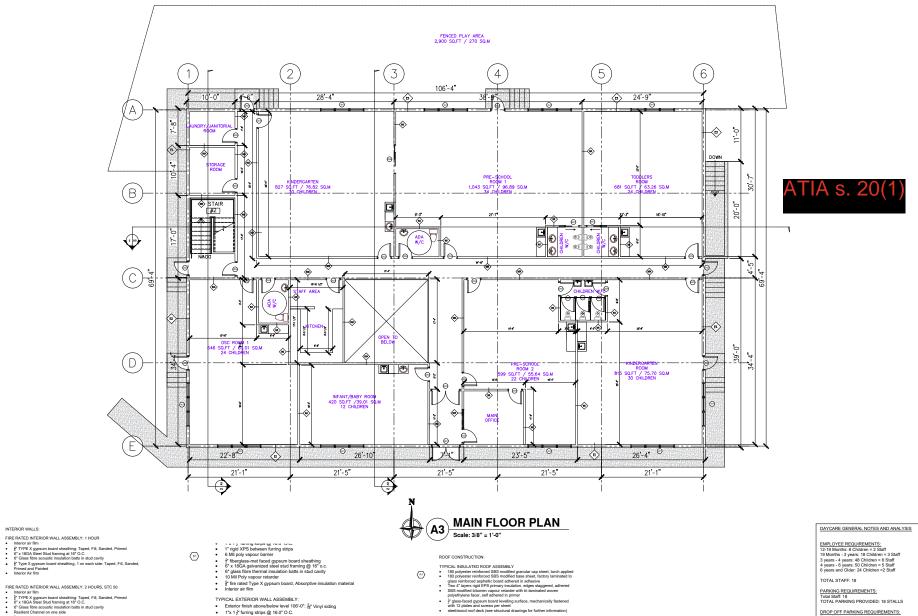


DAYCARE FACILITY 5028 MACTAVISH CRESCENT, FORT MCMURRAY, AB.

DRAWING TITLE

LANDSCAPING DETAIL

Date MARCH 10, 2023 BEC-217 Scale 3 - 1'-0"



INTERIOR WALLS:

(v1)

←

(H3)

FIRE RATED INTERIOR WALL ASSEMBLY: 1 HOUR

FIRE RATED INTERIOR WALL ASSEMBLY: 2 HOURS, STC 50

REMAILED INTERIOR WALL ASSEMBLY: 2 HOURS, STC 50 Interior air film §\* TYPE X gypsum board sheathing: Taped, Fill, Sanded, Primed 6\* x 166A Steel Stud framing at 16\* O.C. 6\* Class file acoustic insulation bats in stud cavity Resilient Channel on one side

\*\* Type X gypsum board sheathing, 2 on each side: Taped, Fill, Sanded, Primed and Panited Interior Air film

TYPICAL INTERIOR WALL ASSEMBLY: NO FIRE RATING

Interior all Engineers Assessment - Northe Notified

† gypsum board sheathing: Taped, Fill, Sanded, Primed

6's 1864. Steel Stud faming at 16' O.C.

6' Glass fibre accusing insulation batts in stud cavity

† gypsum board sheathing, 1 on each side: Taped, Fill, Sanded, Primed
and Painted

Interior Art film

TYPICAL EXTERIOR PLUMBING WALL ASSEMBLY: NO FIRE RATING

3 % x 18GA Steel Stud framing at 16" O.C.
3 % Glass Fiber acoustic insulation batts in stud cavity

Gypsum board sheathing, 1 on each side: Taped, Fill, Sanded, Primed and nainted.

Interior Air Film

TYPICAL EXTERIOR WALL ASSEMBLY:

Exterior finish above/below level 106'-0":  $\frac{5}{16}$ " Vinyl siding 1"x 1 ½" furring strips @ 16.0" O.C.

1" rigid XPS between furring strips 6 Mil poly vapour barrier

6 min poly vapour barrier

2" fiberglass-mat faced gypsum board sheathing
6" x 18CA galvanized steel stud framing @ 16" o.c.
6" glass fibre thermal insulation batts in stud cavity
10 Mill Poly vapour retarder

½" fire rated Type X gypsum board, Absorptive insulation material

TYPICAL EXTERIOR WALL ASSEMBLY:

YPICAL EXTERIOR WALL ASSEMBLY:

8" cast in place concrete below 106-0" level

2x6 Framing @ 16" o.c. with R24 insulation

6mll poly vapour barrier

½" Gypsum board

Interior air film

FLOOR CONSTRUCTION:

TYPICAL INSULATED INTER FLOOR ASSEMBLY: 2 HOUR
Finished flooring materials

g\* Plywood sheathing T&G Floor sheathing ∰\* 11 g\* TJI Joists @ 16\* O.C. w/o insulation

4 layers of \$\frac{5}{8}\$" Type X gypsum board: Taped, filled, sanded, primed and painted.

TYPICAL INSULATED INTER FLOOR ASSEMBLY: 1 HOUR

Finished flooring materials
 ½" Plywood sheathing

T&G Floor sheathing ₩ 11 F T.II Joists @ 16" O.C. w/o insulation

2 layers of §" Type X gypsum board on one side: Taped, filled, sanded, primed and painted.

PARKING REQUIREMENTS:

Total Staff: 18 TOTAL PARKING PROVIDED: 18 STALLS

DROP OFF PARKING REQUIREMENTS:

Total Children: 148 TOTAL DROP-OFF PARKING: 10 stalls

PLAYGROUND CALCULATION: Total Children: 148 Children > 19 Months: 8 Children < 19 Months: 140

Total Playground required = 315 Sq.M Playground Space Provided area = 270 Sq.M Daycare Facility backing onto green space with play park Additional Playspace available. Daycare operator to provide additional information as per Early Learning and Childcare regulation.

CHILDREN SPACING REQUIREMENTS: BABIES: 0-19 Months = 8

TODDLERS: 19 Months - 3 years = 18 PRE-SCHOOL: 3 years - 4 years = 48 KINDER: 4 years - 6 years = 50 OSC: 6 years - 12 years = 24

TOTAL: 148



BUILDER

MAIN FLOOR AREA: 7 498 SOLET BASEMENT AREA: 7,498 SQ.FT

3 2023-01-15 DEVELOPMENT PERMIT REVIEW 1 2022-11-30 DEVELOPMENT PERMIT REVIEW /. yy-mm-dd Revision /Drawing Issue



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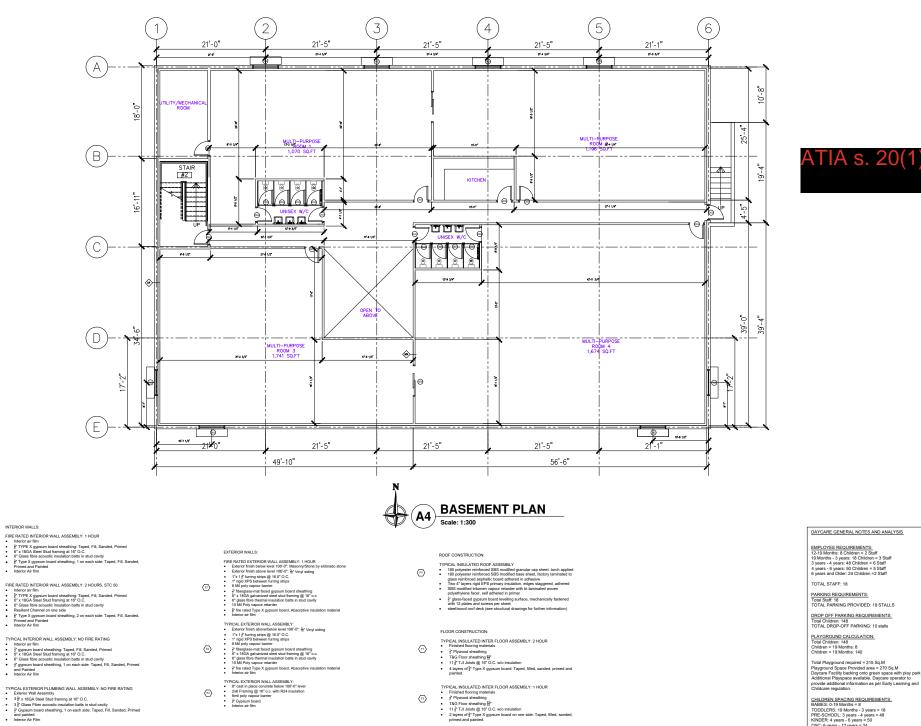
DAYCARE FACILITY 5028 MACTAVISH CRESCENT, FORT MCMURRAY, AB.

DRAWING TITLE

MAIN FLOOR PLAN

Date MARCH 10, 2023 Scale 3 - 1'-0" BEC-217 Drawn by M.K. Checked by A.G.





INTERIOR WALLS:

(v1)

←

(H3)

Interior Air Film

е architects ind 9834-105 Street NW Edmonton, AB, T5K 1A6

ADDITIONAL CONSULTANTS

BUILDER

MAIN FLOOR AREA: 7 498 SOLET BASEMENT AREA: 7,498 SQ.FT

1 2022-11-30 DEVELOPMENT PERMIT REVIEW /. yy-mm-dd Revision /Drawing Issue

BURHANI ENGINEERING AND CONSTRUCTION LTD 8735 53 AVENUE NW EDMONTON AB T6E 5G2 TFI: 587-754-0217

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DAYCARE FACILITY 5028 MACTAVISH CRESCENT, FORT MCMURRAY, AB.

DRAWING TITLE

BASEMENT PLAN

Date MARCH 10, 2023


Scale 3 - 1'-0"

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Drawn by M.K. Checked by A.G.

BFC-217

CHILDREN SPACING REQUIREMENTS: BABIES: 0-19 Months = 8
TODDLERS: 19 Months - 3 years = 18
PRE-SCHOOL: 3 years - 4 years = 48
KINDER: 4 years - 6 years = 50
OSC: 6 years - 12 years = 24

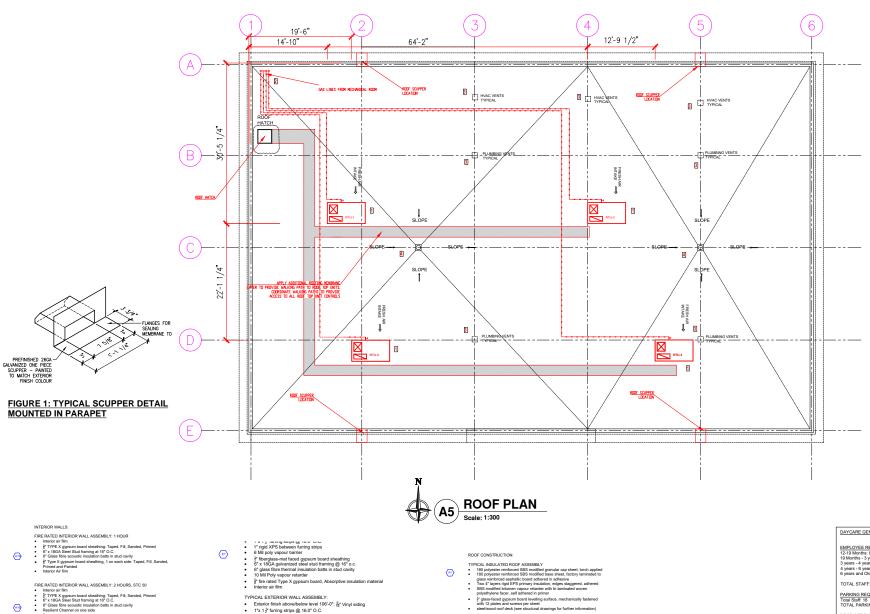

FIRE RATED INTERIOR WALL ASSEMBLY: 2 HOURS, STC 50

REMAILED INTERIOR WALL ASSEMBLY: 2 HOURS, STC 50 Interior air film §\* TYPE X gypsum board sheathing: Taped, Fill, Sanded, Primed 6\* x 166A Steel Stud framing at 16\* O.C. 6\* Class file acoustic insulation bats in stud cavity Resilient Channel on one side

\* g\* Type X gypsum board sheathing, 2 on each side: Taped, Fill, Sanded, Primed and Painted
 Interior Air film

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TYPICAL INTERIOR WALL ASSEMBLY: NO FIRE RATING

Interior all Engineers Assessment - Northe Notified

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6's 1864. Steel Stud faming at 16' O.C.

6' Glass fibre accusing insulation batts in stud cavity

† gypsum board sheathing, 1 on each side: Taped, Fill, Sanded, Primed
and Painted

Interior Art film

TYPICAL EXTERIOR PLUMBING WALL ASSEMBLY: NO FIRE RATING

3 g x 18GA Steel Stud framing at 16" O.C.
3 g Glass Fiber acoustic insulation batts in stud cavity
g Cypsum board sheathing, 1 on each side: Taped, Fill, Sanded, Primed and nativaled.

Interior Air Film

§" fire rated Type X gypsum board, Absorptive insulation materia

TYPICAL EXTERIOR WALL ASSEMBLY:

Exterior finish above/below level 106'-0":  $\frac{5}{16}$ " Vinyl siding 1"x 1 ½" furring strips @ 16.0" O.C.

1" rigid XPS between furring strips 6 Mil poly vapour barrier

6 min poly vapour barrier

2" fiberglass-mat faced gypsum board sheathing
6" x 18CA galvanized steel stud framing @ 16" o.c.
6" glass fibre thermal insulation batts in stud cavity
10 Mill Poly vapour retarder

½" fire rated Type X gypsum board, Absorptive insulation material

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8" cast in place concrete below 106-0" level

2x6 Framing @ 16" o.c. with R24 insulation

6mll poly vapour barrier

½" Gypsum board

Interior air film

#### FLOOR CONSTRUCTION:

TYPICAL INSULATED INTER FLOOR ASSEMBLY: 2 HOUR
Finished flooring materials

g\* Plywood sheathing T&G Floor sheathing ∰\* 11 g\* TJI Joists @ 16\* O.C. w/o insulation

4 layers of \$ Type X gypsum board: Taped, filled, sanded, primed and painted.

#### TYPICAL INSULATED INTER FLOOR ASSEMBLY: 1 HOUR

Finished flooring materials
 ½" Plywood sheathing

T&G Floor sheathing ₩ 11 F T.II Joists @ 16" O.C. w/o insulation

2 layers of §" Type X gypsum board on one side: Taped, filled, sanded, primed and painted.

DAYCARE GENERAL NOTES AND ANALYSIS

EMPLOYEE REQUIREMENTS; 12-19 Months: 8 Children = 2 Staff 19 Months - 3 years: 18 Children = 3 Staff 3 years - 4 years: 48 Children = 6 Staff 4 years - 6 years: 50 Children = 5 Staff 6 years and Older: 24 Children = 2 Staff

TOTAL STAFF: 18

PARKING REQUIREMENTS: Total Staff: 18 TOTAL PARKING PROVIDED: 18 STALLS

DROP OFF PARKING REQUIREMENTS: Total Children: 148 TOTAL DROP-OFF PARKING: 10 stalls

PLAYGROUND CALCULATION: Total Children: 148 Children > 19 Months: 8 Children < 19 Months: 140

Total Playground required = 315 Sq.M Playground Space Provided area = 270 Sq.M Daycare Facility backing onto green space with play part Additional Playspace available. Daycare operator to provide additional information as per Early Learning and Childcare regulation.

CHILDREN SPACING REQUIREMENTS:

BABIES: 0-19 Months = 8
TODDLERS: 19 Months - 3 years = 18
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BUILDER

MAIN FLOOR AREA: 7 498 SOLET BASEMENT AREA: 7,498 SQ.FT

3 2023-03-10 ISSUED FOR PERMITS 1 2022-11-30 DEVELOPMENT PERMIT REVIEW /. yy-mm-dd Revision /Drawing Issue



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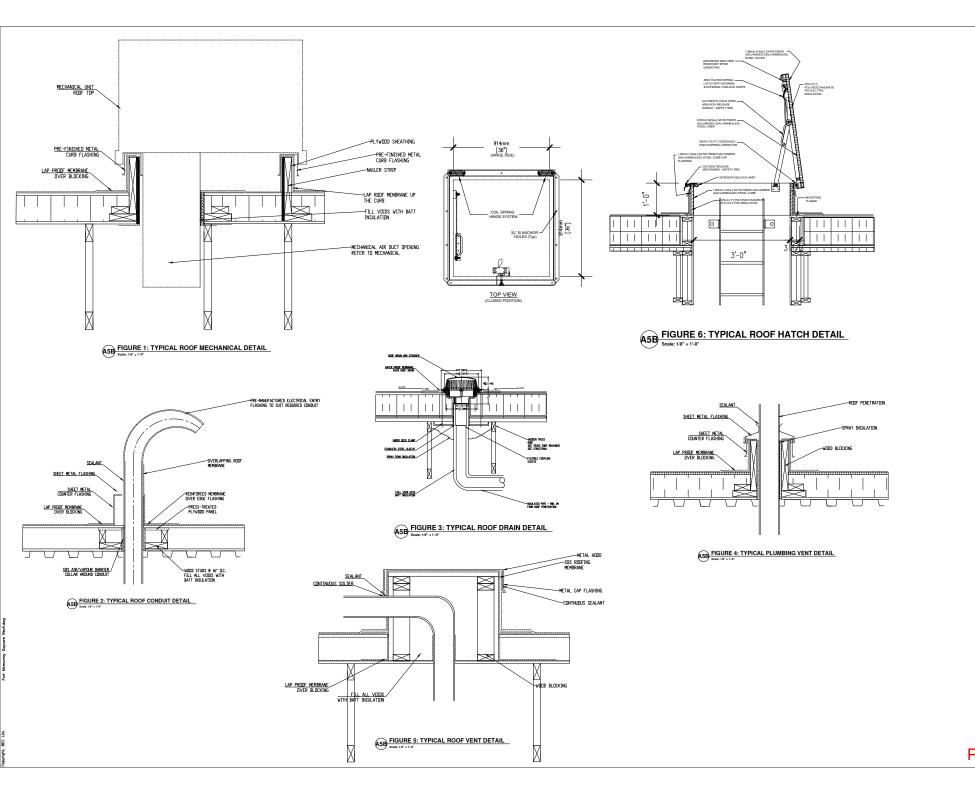
DAYCARE FACILITY 5028 MACTAVISH CRESCENT, FORT MCMURRAY, AB.

DRAWING TITLE

ROOF PLAN

Date MARCH 20, 2023 Scale 3 - 1'-0" BEC-217







BUILDER

MAIN FLOOR AREA: 7,498 SQ. FT BASEMENT AREA: 7,498 SQ.FT

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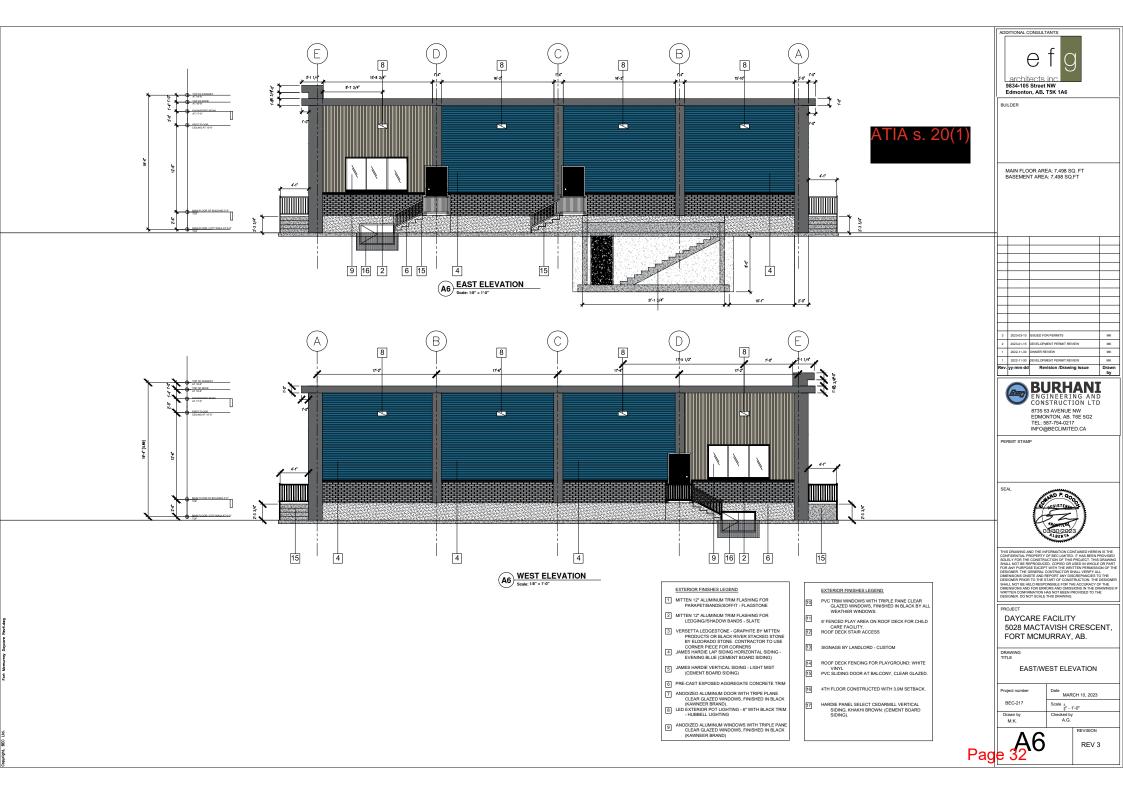
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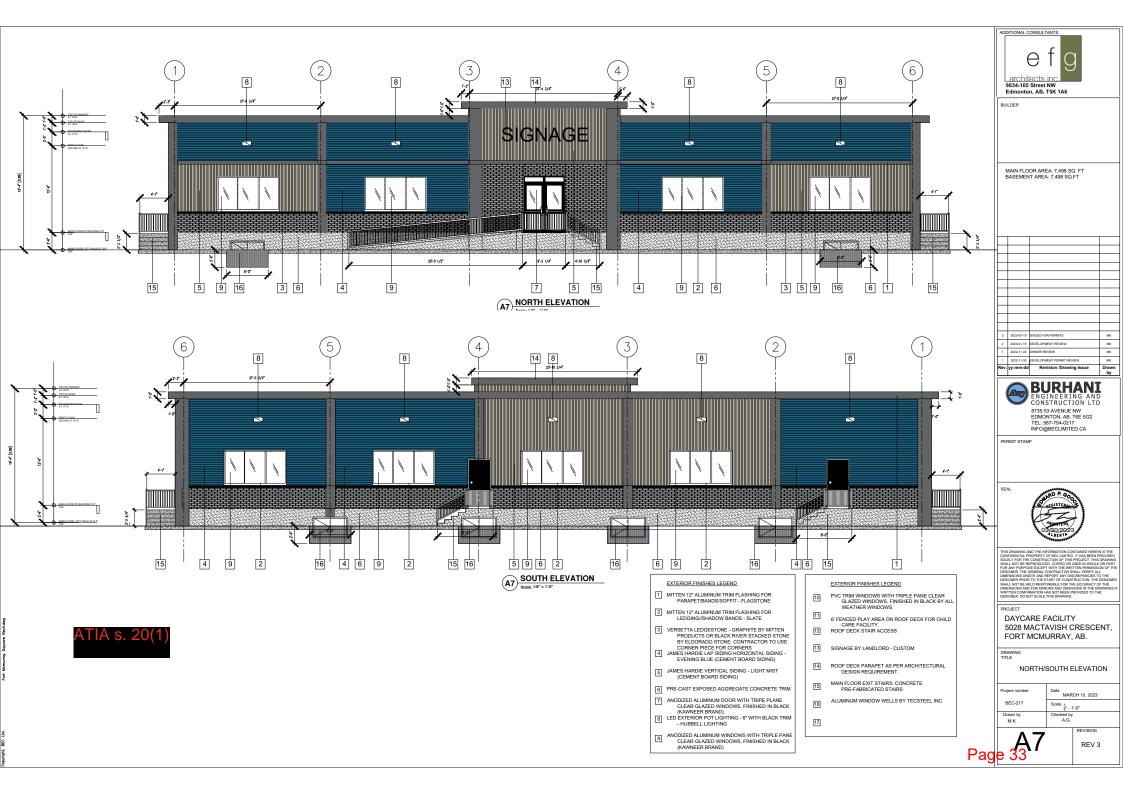
DAYCARE FACILITY 5028 MACTAVISH CRESCENT, FORT MCMURRAY, AB.


DRAWING TITLE

ADDITIONAL DETAIL

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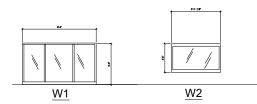




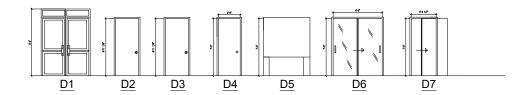

	DOOR SCHEDULE							
NO.	SIZE	DESCRIPTION	DOOR MATERIAL	DOOR FINISH	FRAME MATERIAL	FRAME FINISH	ULC	HARDWARE
D01	8'x6'	EXTERIOR	ALUMINUM	ANODIZED	ALUMINUM	ANODIZED	N/A	DOOR LOCK, TRIPLE PANE GLASS, WEATHER STRIPPING, DOOR CLOSER, PUSH PADDLE FOR EXITING
D2	3' X 7'	EXTERIOR	INSULATED METAL	PAINTED	THERMALL BROKEN PRESSED METAL FRAME	PAINTED	1 HOUR	DOOR LOCK, WEATHER STRIPPING, 1 HOUR RATING, DOOR CLOSER
D3	3' X 7'	INTERIOR	HOLLOW METAL	PAINTED	PRESSED METAL FRAME	PAINTED	1 HOUR	DOOR LOCK, WEATHER STRIPPING, 1 HOUR RATING, DOOR CLOSER
D4	3' X 7'	INTERIOR	HOLLOW CORE WOOD	PAINTED	WOODEN FRAME	PAINTED	NA	LOCK, PAINTED
D5	3' X 7'	INTERIOR	ALUMINUM	ANODIZED	ALUMINUM	ANODIZED	NA	TOILET DOOR PARTITIONING WITH LOCK SYSTEM
D6	6' X 7'	INTERIOR	HOLLOW CORE WOOD	PAINTED	WOODEN FRAME	PAINTED	NA	POCKET DOOR/SLIDING DOOR - 6'-0", LOCK SYSTEM
D7	3' X 7'	INTERIOR	HOLLOW CORE WOOD	PAINTED	WOODEN FRAME	PAINTED	NA	POCKET/SLIDING DOOR, 3'-0", LOCK SYSTEM





WINDOW SCHEDULE						
NO.	SIZE	DESCRIPTION	MATERIAL	FRAME	FINISH	GLASS TYPE
W1	9' W X 5'H	PICTURE	ALUMINUM	ALUMINUM - KAWNEER	ANODIZED	TRIPLE PANE
W2	5'W X 3'H	SLIDER	PVC	PVC	GREY PAINTED	TRIPLE PANE



#### WINDOW NOTES:

1. ALL WINDOWS SUPPLIED IN THIS BUILDING HAVE THE FOLLOWING GLASS PERFORMANCE:
MODEL LOWER HISSCIED SUPPLIED HAVE THE FOLLOWING GLASS PERFORMANCE:
UNAULE: 0.138 TANLE FAME, TWO LOW-E COATING, ARGON UNAULE: 0.138 TANLE FAME, TWO LOW-E COATING, ARGON UNAULE: 0.138 TANLE FAME, TWO LOW-E COATING, ARGON UNAULE: 0.138 TANLE FAME, TANLE FAME, TO SUPPLIED HAVE THE SUPPLIED HAV



BUILDER

MAIN FLOOR AREA: 7,498 SQ. FT BASEMENT AREA: 7,498 SQ.FT

Rev.	yy-mm-dd	Revision /Drawing Issue	Drawn
1		DEVELOPMENT PERMIT REVIEW	MK
1	2022-11-30	OWNER REVIEW	MK
2	2023-01-15	DEVELOPMENT REVIEW	MK
3	2023-03-10	ISSUED FOR PERMITS	MK



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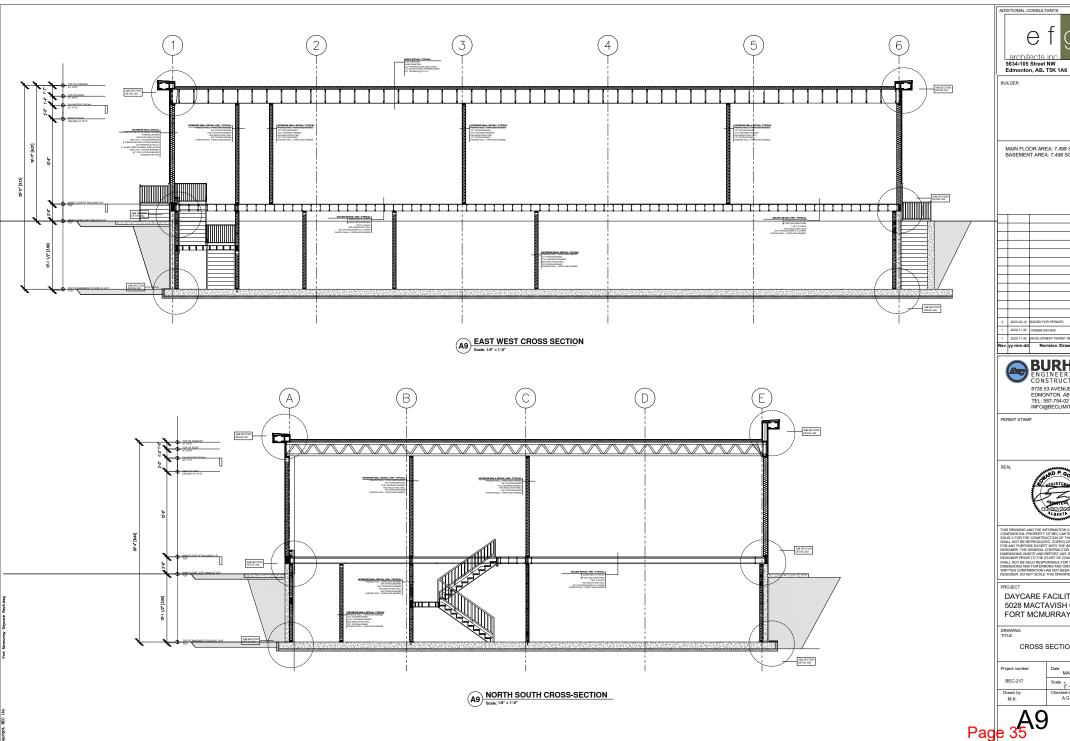
DAYCARE FACILITY 5028 MACTAVISH CRESCENT, FORT MCMURRAY, AB.

DRAWING TITLE

WINDOWS SPECIFICATIONS

	Project number	Date MARCH 10, 2023		
l	BEC-217	Scale 3 8" - 1'-0"		
ı	Drawn by	Checked by		
ı	M.K.	A.G.		







MAIN FLOOR AREA: 7,498 SQ. FT BASEMENT AREA: 7,498 SQ.FT

1 2022-11-30 DEVELOPMENT PERMIT REVIEW








DAYCARE FACILITY 5028 MACTAVISH CRESCENT, FORT MCMURRAY, AB.

CROSS SECTION DETAIL

Project number	Date MARCH 10, 2023		
BEC-217	Scale 3 - 1'-0"		
Drawn by M.K.	Checked by A.G.		

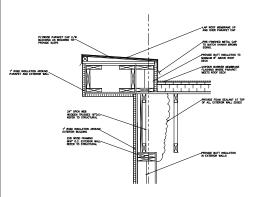

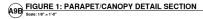

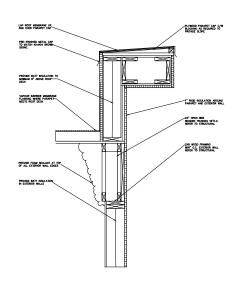

A9B FIGURE 4: PARAPET/CANOPY DETAIL SECTION
Scale: 18" = 1'-0"

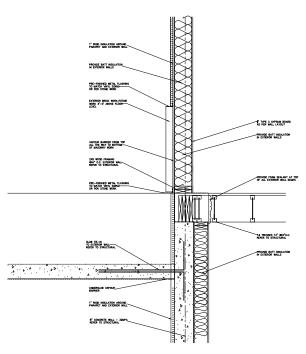


FIGURE 2: CONCRETE FLOOR/WALL DETAIL

Scale: 18" = 1'40"

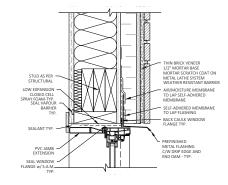


FIGURE 5: TYPICALWINDOW HEADER DETAIL WITH MASONRY WORK


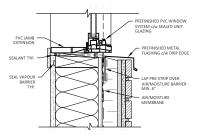


FIGURE 6: TYPICALWINDOW SILL DETAIL WITH MASONRY WORK

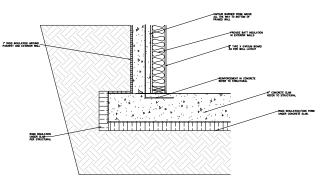

A9B FIGURE 3: CONCRETE FOUNDATION DETAIL

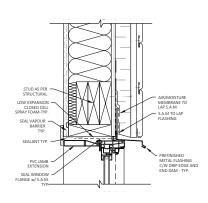


FIGURE 7: TYPICALWINDOW HEADER DETAIL WITH CEMENT BOARD SIDING

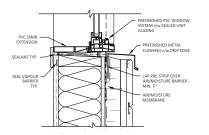


FIGURE 8: TYPICALWINDOW SILL DETAIL WITH CEMENT BOARD SIDING



BUILDER

MAIN FLOOR AREA: 7 498 SOLET BASEMENT AREA: 7,498 SQ.FT





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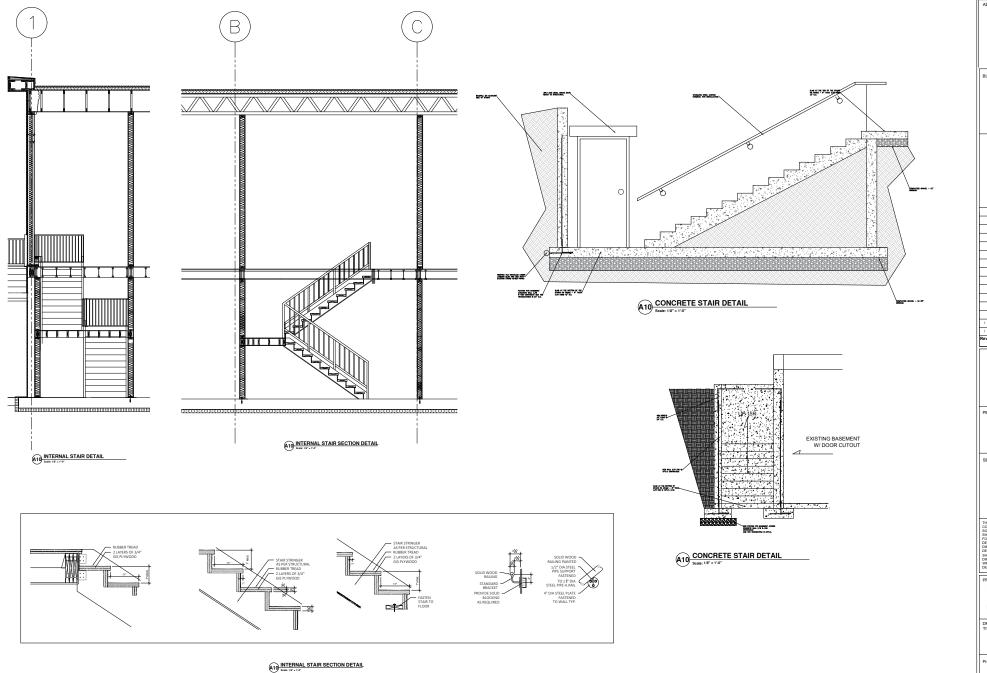
DAYCARE FACILITY 5028 MACTAVISH CRESCENT, FORT MCMURRAY, AB.

DRAWING TITLE

SECTION DETAILS

Date MARCH 10, 2023 BEC-217 Scale 3 - 1'-0"

REV 2



ADDITIONAL CONSULTANTS

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BUILDER

MAIN FLOOR AREA: 7,498 SQ. FT BASEMENT AREA: 7,498 SQ.FT

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PROJECT


DAYCARE FACILITY 5028 MACTAVISH CRESCENT, FORT MCMURRAY, AB.

DRAWING TITLE

STAIR DETAILS

Project number	Date MARCH 10, 2023
BEC-217	Scale 3 - 1'-0"
Drawn by M.K.	Checked by A.G.

A10

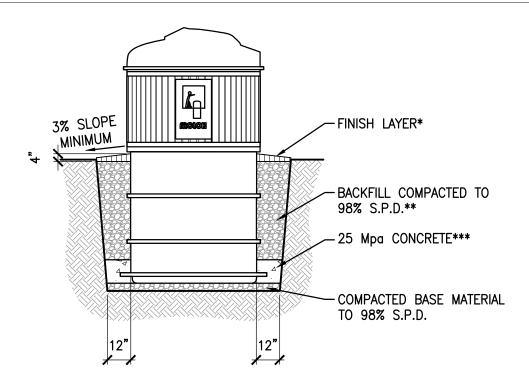

NOTES

FINE GRAVEL, ASPHALT, TOP SOIL, ETC, MAY BE USED AS FINISH LAYER. REFER TO SITE PLAN AND LANDSCAPE DRAWINGS.

\*\*BACKFILL USING SUITABLE BALLAST MATERIAL (EG. GRANULAR 'A'). EXCAVATED SOIL MAY BE USED IF SUITABLE. DO NOT USE MATERIAL THAT CAN FREEZE (CLAY, SILT, OR MUD). STONES WITH DIAMETER GREATER THAN 100mm TO BE REMOVED. COMPACT BALLAST CAREFULLY EVERY 200mm.

\*\*\*M-5000, M-3000, M-1300, AND M-GREASE TO HAVE 300mm THICK CONCRETE. M-800, M-300, AND M-STORAGE TO HAVE 100mm THICK CONCRETE.

CONTAINERS TO BE MINIMUM 300mm FROM OTHER CONTAINERS, WALLS, STRUCTURES, AND UNDERGROUND UTILITIES AND SERVICES.

OPTIONS:

FRAMING: RECYCLED PLASTIC FRAMING (GREY)
LINERS: STANDARD LIFTING BAG
LIDS: STANDARD LID (BLACK)
-RECYCLING W/ CARDBOARD SLOT

FIGURE 1: TYPICAL MOLOK DETAIL
FOLLOW SUPPLIER RECOMMENDATIONS



BUILDER

MAIN FLOOR AREA: 7,498 SQ. FT BASEMENT AREA: 7,498 SQ.FT

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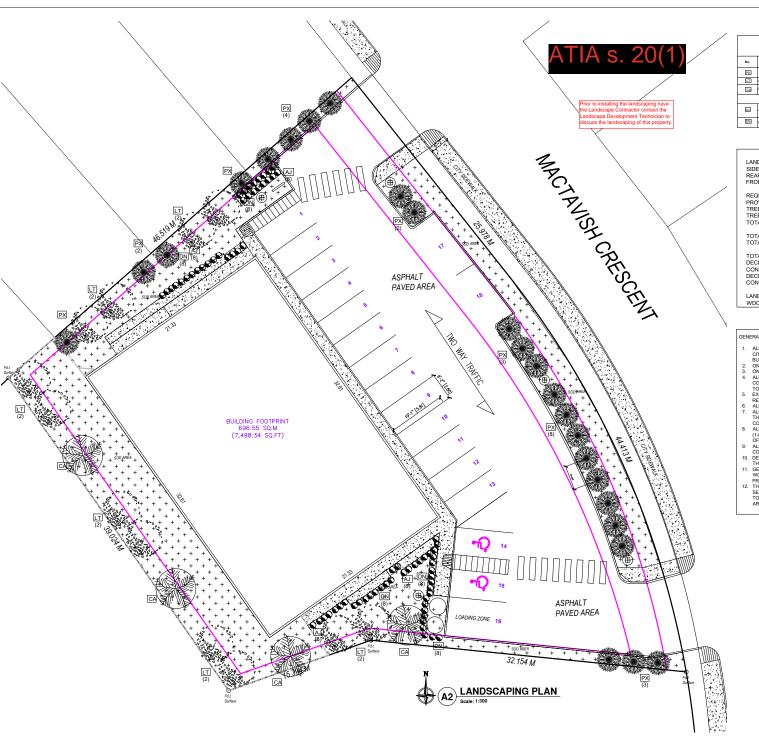
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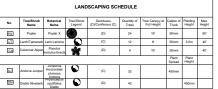
ADDITIONAL DETAILS

REV 1

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LANDSCAPING CALCULATIONS: SIDE SETBACKS: 1.2M REAR SETBACK: 2.0M FRONT SETBACK: 6.0M

REQUIRED LANDSCAPED SPACE: 30% OF 2,466.33 SQ.M = 739.9 SQ.M PROVIDED LANDSCAPED SPACE: 754.3 SQ.M TREES REQUIRED FOR LANDSCAPED AREA: 739.9/25 = 30 TREES TREES REQUIRED FOR PARKING: 18/5 = 4 TREES
TOTAL NO. SHRUBS REQUIRED (YARD): 739.9/25 = 30 SHRUBS

TOTAL TREES REQUIRED: 34 TREES TOTAL SHRUBS REQUIRED: 30 SHRUBS

TOTAL TREE AND SHRUB COUNT PROVIDED: DECIDUOUS TREES: 28 CONIFEROUS TREES: 12 DECIDUOUS SHRUBS: 40 CONIFEROUS SHRUBS: 32

LANDSCAPING PLAN ACCEPTABLE IN ACCORDANCE WITH WOOD BUFFALO LAND USE BYLAW.

#### GENERAL NOTES:

- ALL LANDSCAPING AND PLANTING TO BE COMPLETED IN ACCORDANCE WITH CITY OF FORT MCMURRAY PLANTING GUIDELINES AS SET OUT IN THE WOOD BUFFALO ZONING BYLAW.
   ONE TREE REQUIRED FOR 25W2 OF LANDSCAPED AREA
   ONE SHRUE REQUIRED FOR 25W2 OF LANDSCAPED AREA
   ALL AREAS IN TOWN OF FORT MCMURRAY BOULEVARDS, DAMAGED DURING CONSTRUCTION TO RECEIVE SOO ON 150MM DEPTH COMPACTED CLASS B
   TOWN OF THE CONTROL OF

- EXISTING TREES ALONG EDGE OF ROADWAY OR IN ANY OTHER LOCATION TO REMAIN IN PLOCET TO BE REMOVED FOR CONSTRUCTION.


  ALL NEEDS ON PROPERTY TO BE PLANTED ON THE GROUND ON MULCH BED. THE MULCH BED SHALL BE A MINIMUM OF 2 FEET IN DEPTH AS PER GOOD CONSTRUCTION PRACTICE.

  ALL UTILITIES SHALL BE CONFIRMED BY CALLING ALBERTA ONE CALL (1-800-242-3447) AND ALL UTILITIES SHALL BE MARKED OUT PRIOR TO THE START OF ANY CONSTRUCTION (DISSORRIBED AND NON-BUSSCRIBED UTILITIES).

- OF ANY COMSTRUCTION (SUBSCRIBED AND NON-SUBSCRIBED UTILITIES SHALL BE VERIFIED PRIOR TO THE START OF THE START CONTOR OF THE PROJECT.

  10. ENERGY AND START OF THE START OF THE START CONTOR OF THE PROJECT.

  11. GENERAL CONTRACTOR IS RESPONSIBLE FOR MAINTAINING A CLEAN AND SAFE.
- GEMERAL CONTRACTOR IS RESPONSIBLE FOR MAINTAINING A CLEAN AND SAFE WORKSITS AT ALL TIMES IN ACCORDANCE WITH GOOD CONSTRUCTION PARCTICE AND OSHA REQUIREMENT.
   THE CONTRACTOR SHALL BE RESPONSIBLE FOR EROSION CONTROL AND SEDIMENTATION CONTROL AND SHALL ENSURE THAT ALL EFFORTS ARE MADE TO PREVENT REOSION AND SEDIMENT MOVEMENT ONTO ROADS AND DRAINAGE

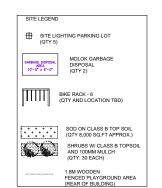



Edmonton, AB. T5K 1A6

MAIN FLOOR AREA: 7 498 SOLET BASEMENT AREA: 7,498 SQ.FT



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DAYCARE FACILITY 5028 MACTAVISH CRESCENT, FORT MCMURRAY, AB.

DRAWING TITLE

LANDSCAPING

Date MARCH 20, 2023 BEC-217 Scale 3 - 1'-0"

REV 5

1.0 GENERAL NOTES: 1.1. No construction shall commence prior to authorization from local authorities 1.2. All construction to be consistent with local and provincial construction standards and national plumbing codes. 1.3. Contractor to confirm all service location points on site prior to construction 2.0 GENERAL PIPE TRENCHING & BACKFILL: 2.1. Excavate trenches to alignment and depth indicated or required and to uniform width, sufficiently wide to conform to safety requirements.

2.2. Excavate soft areas of subgrade, fill with approved material and compact to minimum 100% of standard proctor density (spd). 2.3. Where compaction may not be achieved please refer to geotechnical consulting representative.

2.4. Class-b bedding to be used throughout, or an municipality approved equivalent. 2.5. Grade and shape pipe trench to give uniform and even bearing for each length of pipe c/w bell holes at each joint as required. 2.6. Backfill trenches using fill materials specified by geotechnical report and/or on-site

geotechnical representatives. 2.7. All backfill to be clean native or engineered fill, unfrozen and uniformly compacted in layers not exceeding 150mm to 98% standard proctor density (spd), 98% spd for final 600mm to subgrade elevation, performed in a manner that avoids damage or displacement of services.

2.8. Remove and replace the frozen material with appropriate bedding material. 2.9. Compact material around pipe with hand tampers properly shaped to ensure full compaction below haunches. do not use mechanical tampers over top of pipe where cover is

less than 300 mm. 3.0 FROST BOX: 3.1. Use dow hI-40 styrofoam or approved equivalent for storm and sanitary services with

less than 2.0m ground cover. 3.2. Use dow hI-40 styrofoam or approved equivalent for water services with less than 3.0m around cover.

3.3. Pipe insulation requirements may vary, confirm with municipality standards and guidelines for minimum depth requirements. 4.0 WATER:

4.1. Pipe and pipe fittings

4.1.1. Provide factory-fabricated pipe and pipe fittings of sizes, types, pressure ratings, and joining methods indicated.

4.1.2. Steel pipe and pipe fittings: 4.1.2.1. Pipe: to ANSI/AWWA C200. 4.1,2.2, Fittings: to ANSI/AWWA C208.

4.1.2.3. Internal lining: cement-mortar, to ANSI/AWWA C205. 4.1.2.4. External coating: polyethylene jacket.

4.1.3. Polyvinyl chloride (PVC) pipe and fittings:

4.1.3.1. Pipe: AWWA C900 (100 to 300mm) DR 18. AWWA C905 (350 or greater) DR 25

4.1.3.2. Fittings: to CSA B137.3.

4.1.3.3. Joints: gasketed bell end, to CSA B137.3.
4.1.4. Polyethylene (PE) pipe and fittings:
4.1.4.1. Pipe sizes up to and including NPS 6: to CSA B137.1.

4.1.4.2. Pipe sizes over NPS 6: to CGSB 418GP825M. 4.1.4.3. Fittings: cast iron, to ansi/awwa C110/A21.10.

4.1,4,4. Joints: butt welded and/or mechanical. 4.1.4.5, Copper pipe: to ASTM B88.

4.2. Valves, valve boxes, and valve casings

4.2.1. Valves are to be placed within road right of way or landscaped areas. valves are not permitted within sidewalk or curb & gutters.

4.2.2. Gate valves: to ANSI/AWWA C500, non-rising stem, square body, to open

4.2.3. Valve boxes: cast iron, adjustable over a minimum of 450mm complete with valve operating extension rod.

4.2.4. Corporation main stops, curb stops and curb boxes: to ANSI/AWWA C800-89. 4.2.5. Steel pipe casings to conform to AWWA C200, minimum tensile strength 207

4.2.6. Provide type 'b' (screw type) valve casing set with plug

4.2.7. Provide type 'b' (screw type) middle extension for valves with depths in excess of 3.0m from top of operating nut.

4.2.8. Operating nut must be between 1.8m and 2.5m to surface grade use valve stem

risers (extensions) with stone catcher flange.
4.2.9. Depth of valve casing to paved finished grade to be within 0mm to 5mm.

Installation of pipe and pipe fittings
 4.3.1. Steel pipe; install to ANSI/AWWA M11.

4.3.2. PVC & PE pipe: install in accordance with manufacturer's installation instructions.

4.4. Joint connection methods

4.4.1. Steel to steel:

4.4.1.1. Welded: to ANSI/AWWA c206 4.4.1.2. Steel flanges: to ANSI/AWWA c207

4.4.2. PVC to PVC: 4.4.2.1. Gasketed bell-end joints: to CSA B137.3. 4.4.2.2. Solvent cemented joints: to CSA B137.3.

4.4.3. PVC to cast iron fittings: 4.4.3.1, Rubber gasket joints: to ANSI/AWWA C111/A21.11.

444 PF to PF

4.4.4.1. Thermal butt fusion welded joints: in accordance with manufacturer's recommendations.

4.4.5. PE to cast iron fittings:

4.4.5.1. Flanged joints; in accordance with manufacturer's recommendations.

4.5.1. Hydrants: to ANSI/AWWA C502-94, compression type, complying with requirements of local authority having jurisdiction.

4.5.2. Locate and set hydrants plumb, locate pumper nozzle perpendicular to the roadway set to grade, with nozzle 500mm above ground minimum. locate control valve min 0.3m and max 1.2m from hydrant.

4.5.3. Hydrant valves are to be placed within road right of way or landscaped areas valves are not permitted within sidewalk or curb & gutters.

4.6. Testing procedures

4.6.5. Disinfection (chlorination) test water line as per AWWA standard C651, and by continuous feed method as per or local authority having jurisdiction. 4.6.6. Pressure and leakage test water line as per AWWA standard C605 and AWWA manual M23, or local authority having jurisdiction.

4.6.7. Super chlorinated water shall not be discharged to the storm sewer system without de-chlorination of discharge water . 4.6.8. Bacteriological testing shall be carried out on all Installed works and shall be

commissioned into use only after acceptable test results are achieved 4.6.9. Strathcona County Officials to be notified 24 hours prior to chlorination, flushing and bacteriological sample collection.

5. SANITARY AND STORM:

5.1. Materials schedule

5.1.1. PVC pipe and PVC pipe fittings: 5.1.1.1.1. Smooth wall pipe: CSA B182.1 (100 to 150mm) SDR 35 or SDR 28.CSA B182.2-95 (200 to 675mm) SDR 35 or SDR 28.

5.1.1.2. Ultra rib pipe: CSA B182.4 (200mm to 600mm) or ASTM F794 or approved equivalent

5.1.1.3. Joints: rubber gasketed, bell end.

5,1,2, Non-reinforced concrete pipe: 5,1,2,1, Pipe: CSA A257,0 class 3 sulfate resistant cement.CSA 257,1 (up to 600mm) class 3 sulfate resistant cement

5.1.2.2. Joints: rubber gasket to CSA A257.3-M92.

5.1.2.3. Grout: non-shrinking cement mortar or bituminous sealant approved by

manufacturer of precast components 5.1.3. Corrugated steel:

5.1.3.1. Pipe: CSA-G401 galvanized.

5.1.3.2. Joints: welded

5.1.4. Precast manhole

5.1.4.1. Type: ASTM C76 sulfate resistant cement c/w galvanized ladder rungs. 5.1.4.2. Joints: rubber gasket to CSA A257.3-M92.

5 1 5. Precast manhole base, slab top: 5.1.5.1. Type: sulfate resistant cement.

5.1.5.2. Grout: non-shrinking cement mortar or bituminous sealant approved by manufacturer of precast components.

5.1.6. Manhole cover:

5,1,6,1. Type: F80 or as specified. 5.1.6.2. Material: standard cast iron.

5.1.7. Catch basin: 5.1.7.1. Type: as detailed.

5.1.8 Catch basin cover 5.1.8.1. Hard surfaces: frame and cover F38 or as specified landscape

surfaces; frame and cover F39 or as specified. 5.1.8.2. Type: as detailed, standard cast iron.

5.2 Installation notes

5.2.1. Lay pipes with bell-end upgrade.

5.2.2. Provide and utilize "laser" type instrument to control line and grade for grades less than 0.5%. for steeper grades, use approved and accepted methods of establishing grades.

6. EARTHWORKS TESTING:

6.1. General requirements

6.1.1. Applicable test methods for earthwork testing specified in this section:

6.1.2. Particle size analysis of fill materials: testing for conformance with specified graduation limits will utilize testing sieves complying with CAN/CGSB-8.2-M88, sieves, testing, woven wire, metric. 6.1.3. Compaction testing: to ASTM D698, laboratory compaction characteristics of soil using

standard effort.

6.2. Testing agency services

6.2.1. Comply with requirements as outlined in municipal standards. 6.2.2. Cooperate with testing agency in site sampling for testing.

6.3. Fill material testing

6.3.1. Provide on site, for testing purposes, 1.0 m3 of each type of imported fill material. 6.3.2. Imported fill materials will be tested, before placement, for conformance with requirements specified by Geo-technical Engineer's recommendation and specification. 6.3.3. Native excavated material to be used as fill material will, before placement, be inspected for compliance with requirements specified by Geo-technical Engineer's

recommendation and specification. 6.4, Compaction testing

6.4.1. Compaction testing will be performed during fill material placement operations to ensure that specified minimum compaction requirements are met.

7. EARTHWORKS:

7.1. General requirements

7.1.1. "earth excavation" includes:

7.1.1.1. Removal and disposal of obstructions, the extent of which is

visible on ground surface.

7.1.1.2. Removal and disposal of earth and other materials encountered, of any classification, except rock,

7.1.1.1. Trenches in excess of 3,00m in width and pits in excess of 9m in either length or width will be classified as open excavation. 7.2. Unauthorized excavation

7.2.1. Unauthorized excavation shall be any excavation beyond elevations and dimensions indicated, without specific direction by consultant. 7.2.2. Fill unauthorized excavation to elevations and dimensions indicated, as

directed by consultant. 7.2.3. Unauthorized excavation and remedial work shall be at contractor's expense

7,3,1. Notify consultant if unsuitable bearing materials are encountered at indicated elevations.

7.3.2. Carry excavation deeper and replace excavated material with suitable materials if and as directed by consultant

7.3.3. Notify consultant if bearing conditions are fulfilled at elevations above those

7.3.4 Adjust excavation elevations if and as directed by consultant

7.4. Preparation prior to commencing excavation:

7.4.1. Contact all affected utility companies regarding exact location and current status of all utilities, voltage of underground and overhead power lines and pressure of natural gas lines.

7.4.2. Notify consultant if any utility lines have been omitted from or incorrectly indicated on drawings

7.4.3. Identify known underground utilifies, stake and flag locations identify and flag surface and aerial utilities.

7.4.4. Notify utility company to remove and relocate utility lines 7.4.5. Expose building connections, service connections and utilities to be

crossed to confirm horizontal and vertical alignment of existing utilities, 7.4.6. Expose existing utility lines by hand excavation to confirm location before

machine digging within 600mm of lines, 7.4.7. Maintain and protect existing above and below grade utilities which pass through work area, protect active utility lines exposed by excavation, from

damage, hand excavate to final elevations and dimensions. 7.4.8. Where existing pipes, ducts or other underground services intersect a trench, support trench in a manner approved by utility.

7.4.9. Where existing overhead line poles are adjacent to excavations, temporarily support poles in a manner approved by utility.

7.5. Dewatering

7.5.1. Maintain excavations free of water. provide pumps, piping, temporary drains, trenches, sumps, and related equipment to remove water 7.5.2. Do not use sanitary sewers or private property for discharge of water.

7.6.1. Strip topsoil from areas to be excavated or filled. 7.6.2. Do not excavate under wet conditions or when such conditions are

anticipated. 7.7. Backfilling

7,7,1. Ensure areas to be backfilled are free of debris, snow, ice, water and that surfaces are not frozen, do not backfill over porous, wet, or spongy subgrade surfaces

7.7.2. Backfill systematically, as early as possible, to allow maximum time for natural settlement

7.8 Compaction

7.8.1. Compact fill materials using only mechanical methods, do not use hydraulic

7.8.2. Do not perform compaction using vehicles and other equipment not designed for compacting. 7.8.3. Maintain optimum moisture content of materials being compacted, as required to attain specified compaction density

8.0 SITE EXCAVATING, FILLING AND GRADING:

8.1. Excavation

8.1.1. Excavate to elevations and dimensions indicated on drawings within a tolerance of ±50mm.

8.2. Placement and compaction of fill materials

8.2.1. Backfill excavations and fill to required subgrade elevations using fill materials specified by geotech recommendation.

8.2.2. Place fill materials in layers not exceeding loose thickness specified by geotech recommendation.

8.2.3. Compact each layer of fill to minimum percentages of standard proctor density specified by geotech recommendation.

8.3 Grading

8.3.1. Make changes in grade natural, blend slopes into level areas.

8.3.2. Unless otherwise indicated on drawings, slope grade away from building minimum

8.3.3. Grade and shape surfaces within following tolerances from subgrade elevations indicated on drawings:

8.3.3.1 Landscaped areas: +50mm 8.3.3.2. Under paved areas: ±50mm. 8.3.3.3 Under sidewalks: +50mm

DRAWING LEGEND C1.0 General Notes and Information C2.0 C3.0 Existing Grading Plan C3.1 New Grading Plan C4.0 Additional Detail



ENGINEERING DEPARTMENT



е



v. yy-mm-dd Revision /Drawing issue

2023-01-16 DWNER REVIEW



SEAL


PROJEC1 DAYCARE FACILITY 5028 MACTAVISH CRESCENT. FORT MCMURRAY, AB.

DRAWING CIVIL NOTES

MARCH 10, 2023 BEC-217 Scale 3" - 1'-0" A.G. M.K.

REV 2

Page 40

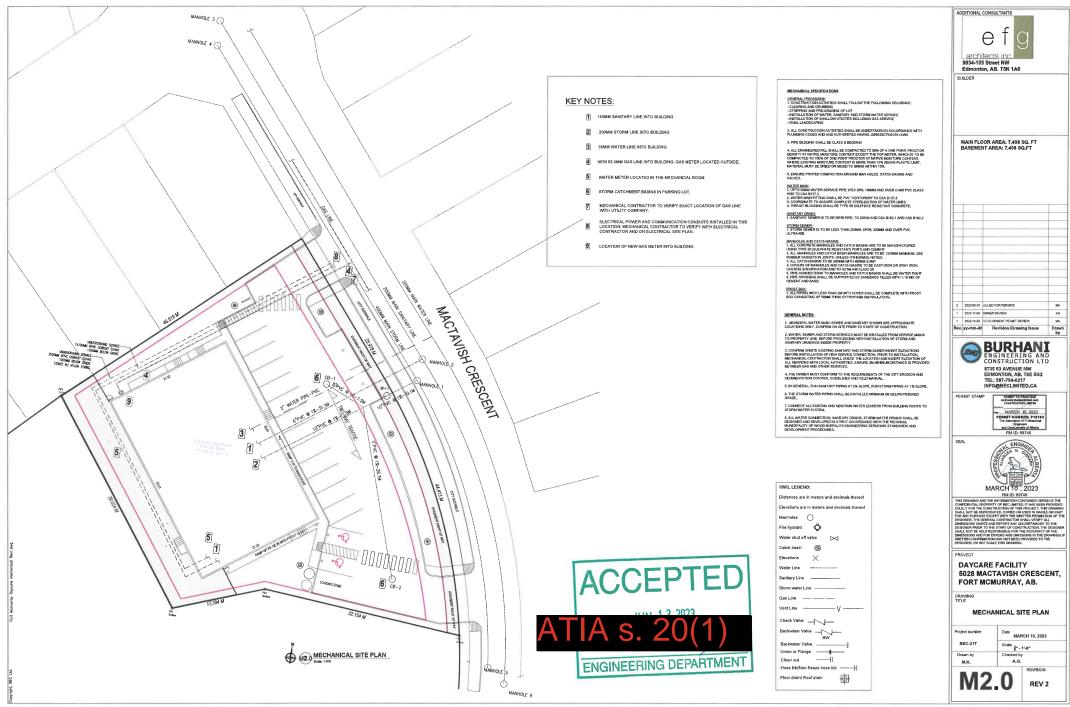



	M2	Hectares	Acres
TOTAL AREA OF DEVELOPMENT	2466.33	0.247	0.609
STORM WATER MAXIMUM ALLOWED VOLUME	L/s/Ha	Volume (L/S)	Volume (CF/S
	35.00	8.632	0.305
SURFACE AREAS	M2	Hectares	Acres
GRASS AREA	754.30	0.075	0.186
GRAVEL AREA	0.00	0.000	0.000
PAVED AREA	1014.70	0.101	0.000
ROOF AREA	697.00	0.070	0.172
TOTAL AREA	2466.00	0.247	0.609
COMBINED RUN OFF COEFFICIENT	FACTOR	COEFFICIENT	
GRASS AREA	0.3	0.023	
GRAVEL AREA	0.5	0.023	
PAVED AREA	0.95	0,096	
ROOF AREA	0.95	0.066	
TOTAL AREA (SUM OF COEFFICIENTS)	2.7	0.185	
POST DEVELOPMENT RUNOR		T .	
TOTAL AREA IN HA / SUM OF COEFFICIENTS	0.751		
STORAGE VOLUME REQUIRED IN M3/HA TO RETAIN PRE-D	D (EL ODB SENT		
STORAGE VOLUME REQUIRED IN MIS/ NA TO RETAIN PRE-D	EAELONMENT	RATE OF OUTFL	OW (1:5 YEAR)
1:5 year Runoff rate	63.9	mm/hr	10 min IDF
		-	
1:5 year Runoff rate 1:25 year Runoff rate	63.9 95.1	mm/hr mm/hr	10 min IDF 10 min IDF
1:5 year Runoff rate 1:25 year Runoff rate STORAGE REQUIRED: BASED ON 5 YEAR EVENT	63.9 95.1	mm/hr	10 min IDF 10 min IDF
1:5 year Runoff rate 1:25 year Runoff rate STORAGE REQUIRED: BASED ON 5 YEAR EVENT 101mm/hr - 67.7 mm/hr x 10min x 60s/min	63.9 95.1 USF	mm/hr mm/hr	10 min IDF 10 min IDF
1:5 year Runoff rate  1:25 year Runoff rate  STORAGE REQUIRED: BASED ON 5 YEAR EVENT  101mm/hr - 67.7 mm/hr x 10min x 60s/min  Q1=C x I x A / 360	63.9 95.1 USH	mm/hr mm/hr NG RATIONAL N	10 min IDF 10 min IDF
1:5 year Runoff rate 1:25 year Runoff rate STORAGE REQUIRED: BASED ON 5 YEAR EVENT 101mm/hr - 67.7 mm/hr x 10min x 60s/min	63.9 95.1 USF	mm/hr mm/hr	10 min IDF 10 min IDF
1:5 year Runoff rate  1:25 year Runoff rate  STORAGE REQUIRED: BASED ON 5 YEAR EVENT  101mm/hr - 67.7 mm/hr x 10min x 60s/min  Q1=C x I x A / 360	63.9 95.1 USH	mm/hr mm/hr NG RATIONAL N	10 min IDF 10 min IDF
1:5 year Runoff rate  1:25 year Runoff rate  STORAGE REQUIRED: BASED ON 5 YEAR EVENT  101mm/hr - 67.7 mm/hr x 10min x 60s/min  Q1=C x   x A / 360  Q2=C x   x A / 360	63.9 95.1 USH 0.033 0.049	mm/hr mm/hr NG RATIONAL N Q (1:5) Q (1:25)	10 min IDF 10 min IDF
1:5 year Runoff rate  1:25 year Runoff rate  STORAGE REQUIRED: BASED ON 5 YEAR EVENT  101mm/hr - 67.7 mm/hr x 10min x 60s/min  Q1=C x I x A / 360  Q2=C x I x A / 360  V = Q1 x 10 min x 60s/min (1:5 year flood)  V=Q2 X 10min x 60s/min (1:25 year flood)	0.033 0.049 19.728 29.361	mm/hr mm/hr NG RATIONAL N Q (1:5) Q (1:25) M3 M3	10 min IDF 10 min IDF
1:5 year Runoff rate  1:25 year Runoff rate  STORAGE REQUIRED: BASED ON 5 YEAR EVENT  101mm/hr - 67.7 mm/hr x 10min x 60s/min  Q1=C x I x A / 360  Q2=C x I x A / 360  V = Q1 x 10 min x 60s/min (1:5 year flood)	0.033 0.049 19.728 29.361	mm/hr mm/hr NG RATIONAL N Q (1:5) Q (1:25) M3 M3	10 min IDF 10 min IDF
1:5 year Runoff rate  1:25 year Runoff rate  STORAGE REQUIRED: BASED ON 5 YEAR EVENT  101mm/hr - 67.7 mm/hr x 10min x 60s/min  Q1=C x 1 x A / 360  Q2=C x 1 x A / 360  V = Q1 x 10 min x 60s/min (1:5 year flood)  V=Q2 X 10min x 60s/min (1:25 year flood)  POND AREA CALCULATED FROM VOLUME (0.1M DEPTH)	03.9 95.1 USI 0.033 0.049 19.728 29.361 197.281 2122.745	mm/hr mm/hr NG RATIONAL N Q (1:5) Q (1:25) M3 M3 M3 FT2	10 min IDF 10 min IDF
1:5 year Runoff rate  1:25 year Runoff rate  STORAGE REQUIRED: BASED ON 5 YEAR EVENT  101mm/hr - 67.7 mm/hr x 10min x 60s/min  Q1=C x I x A / 360  Q2=C x I x A / 360  V = Q1 x 10 min x 60s/min (1:5 year flood)  V=Q2 X 10min x 60s/min (1:25 year flood)	0.033 0.049 19.728 29.361	mm/hr mm/hr NG RATIONAL N Q (1:5) Q (1:25) M3 M3	10 min IDF 10 min IDF
1:5 year Runoff rate  1:25 year Runoff rate  STORAGE REQUIRED: BASED ON 5 YEAR EVENT  101mm/hr - 67.7 mm/hr x 10min x 60s/min  Q1=C x 1 x A / 360  Q2=C x 1 x A / 360  V = Q1 x 10 min x 60s/min (1:5 year flood)  V=Q2 X 10min x 60s/min (1:25 year flood)  POND AREA CALCULATED FROM VOLUME (0.1M DEPTH)	0.033 0.049 19.728 29.361 197.281 2122.745 3297.000	mm/hr mm/hr NG RATIONAL N Q (1:5) Q (1:25) M3 M3 M2 FT2 FT2	10 min IDF 10 min IDF
1:5 year Runoff rate  1:25 year Runoff rate  STORAGE REQUIRED: BASED ON 5 YEAR EVENT  101mm/hr - 67.7 mm/hr x 10min x 60s/min  Q1=C x1 x A / 360  Q2=C x1 x A / 360  V = Q1 x 10 min x 60s/min (1:5 year flood)  V=Q2 x 10min x 60s/min (1:25 year flood)  POND AREA CALCULATED FROM VOLUME (0.1M DEPTH)  POND AREA PROVIDED PER DESIGN	0.033 0.049 19.728 29.361 197.281 2122.745 3297.000	mm/hr mm/hr NG RATIONAL N Q (1:5) Q (1:25) M3 M3 M2 FT2 FT2	10 min IDF 10 min IDF
1:5 year Runoff rate  1:25 year Runoff rate  STORAGE REQUIRED: BASED ON 5 YEAR EVENT  100 mm/hr - 67.7 mm/hr x 10min x 60s/min  Q1=C x   x A / 360  Q2=C x   x A / 360  V = Q1 x 10 min x 60s/min (1:5 year flood)  V=Q2 X 10min x 60s/min (1:5 year flood)  POND AREA CALCULATED FROM VOLUME (0.1M DEPTH)  POND AREA PROVIDED PER DESIGN  ORIFICE SIZING (BASED ON P	0.033 0.049 19.728 29.361 197.281 2122.745 3297.000	mm/hr mm/hr NG RATIONAL N Q (1:5) Q (1:25) M3 M3 M2 FT2 FT2	10 min IDF 10 min IDF
1:5 year Runoff rate  1:25 year Runoff rate  STORAGE REQUIRED: BASED ON 5 YEAR EVENT  101mm/hr - 67.7 mm/hr x 10min x 60s/min  Q1=C x 1 x A / 360  Q2=C x 1 x A / 360  V=Q1 x 10 min x 60s/min (1:5 year flood)  V=Q2 X 10min x 60s/min (1:25 year flood)  POND AREA CALCULATED FROM VOLUME (0.1M DEPTH)  POND AREA PROVIDED PER DESIGN  ORIFICE SIZING (BASED ON P	63.9 95.1 USI 0.033 0.049 19.728 29.361 197.281 2122.745 3297.000	mm/hr mm/hr NG RATIONAL N Q (1:5) Q (1:25) M3 M3 M2 FT2 FT2	10 min IDF 10 min IDF
1:5 year Runoff rate  1:25 year Runoff rate  STORAGE REQUIRED: BASED ON 5 YEAR EVENT 101mm/hr - 67.7 mm/hr x 10min x 60s/min Q1=C x I x A / 360  Q2=C x I x A / 360  V = Q1 x 10 min x 60s/min (1:5 year flood) V=Q2 x 10min x 60s/min (1:25 year flood)  POND AREA CALCULATED FROM VOLUME (0.1M DEPTH)  POND AREA PROVIDED PER DESIGN  ORIFICE SIZING (BASED ON P Q (RELEASE) = Q (MAX) x AREA Q (MAX)	63.9 95.1 USII 0.033 0.049 19.728 29.361 2122.745 3297.000 OND VOLUME 0.033	mm/hr mm/hr  NG RATIONAL N  Q (1:5)  Q (1:25)  M3  M3  M2  FT2  FT2  FT2  M3/S/Ha	10 min IDF 10 min IDF
1:5 year Runoff rate  1:25 year Runoff rate  STORAGE REQUIRED: BASED ON 5 YEAR EVENT  101mm/hr - 67.7 mm/hr x 10min x 60s/min  Q1=C x l x A / 360  Q2=C x l x A / 360  V = Q1 x 10 min x 60s/min (1:5 year flood)  V=Q2 X 10min x 60s/min (1:25 year flood)  POND AREA CALCULATED FROM VOLUME (0.1M DEPTH)  POND AREA PROVIDED PER DESIGN  ORIFICE SIZING (BASED ON POLYMEN)  Q (RELEASE) = Q (MAX) x AREA  Q (MAX) Q (RELEASE)	63.9 95.1 USII 0.033 0.049 19.728 29.361 197.281 2122.745 3297.000 OND VOLUME	mm/hr mm/hr NG RATIONAL N Q (1:5) Q (1:25) M3 M3 M2 FT2 FT2 FT2	10 min IDF 10 min IDF

STORM WATER POND REQUIREMENTS: POST DEVELOPMENT RUNOFF COEFFICIENT: C=[(0.3\*GRASS)+(0.5\*GRAVEL)+(0.95\*PAVED)+(0.95\*ROOF)/TOTAL AREA 1:5 YEAR POST DEVELOPMENT RUN-OFF RATE (10 MIN IDF = 63.9 MM/HR) Q=C+I+A/60 1:25 YEAR POST DEVELOPMENT RUN-OFF RATE (10 MIN IDF = 95.1 MM/HR) Q=C\*I\*A/60 [Data obtained from the Page 362 of Regional Municipality of Wood Buffalo's Engineering servicing standards and development procedures STORAGE REQUIRED (1:25 YEAR RATE - 1:5 YEAR RATE) X 10 MIN X 60S/MIN V=(Q 1:25) - (Q 1:5) X 10MIN X 60S/MIN POND REQUIRED: 19.73 M3 POND CREATED: 30.62 M3

Elevations are in maters and decimals there
Manholes
Fire hydrant 🗘
Water shut off valve
Catch basin
Elevations
Water Line
Sanitary Line
Storm water Line
Gas Line
Vent Line
Check Valve
Backwater Valve BW
Backwater Valve
Union or Flange
Clean out
Hose bib/Non freeze hose bib
Floor drain/ Roof drain


Distances are in meters and decimels thereof


CIVIL LEGEND:



DAYCARE FACILITY 5028 MACTAVISH CRESCENT FORT MCMURRAY, AB.				
DRAWING TITLE		.,		
STOR	M MANA	SEMENT		
Project number	Date MA	ARCH 10, 2023		
BEC-217	Scale 3	- 1'-0"		
Drawn by M.K.	Checked A.6	-,		
C2	0	REVISION		

PROJECT

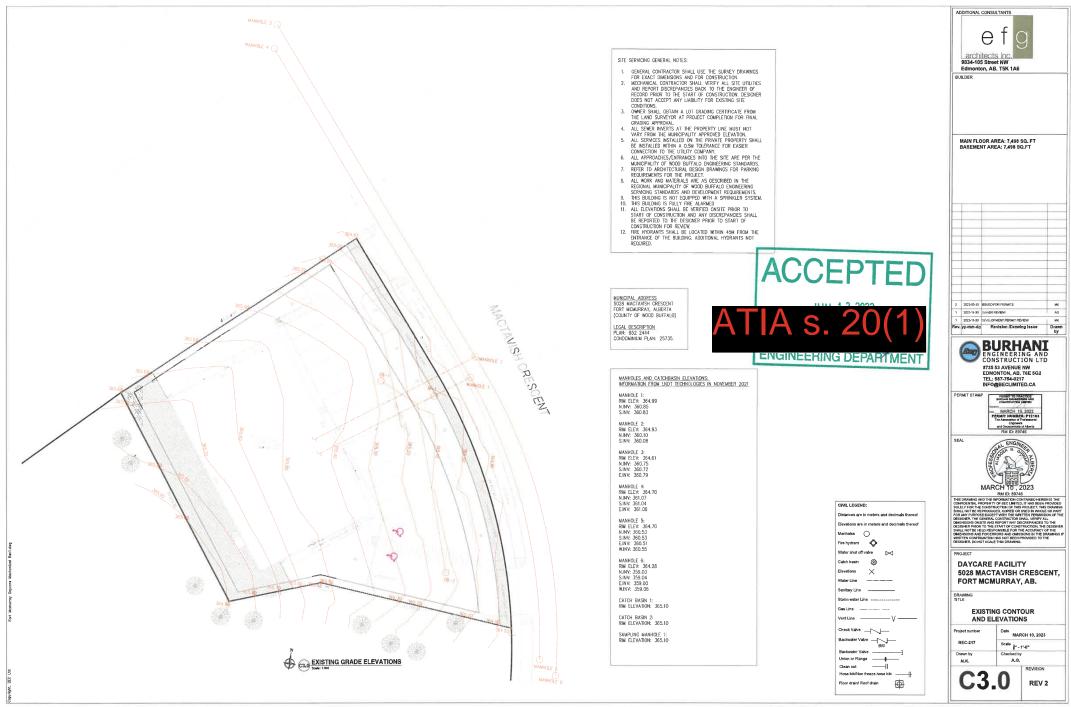

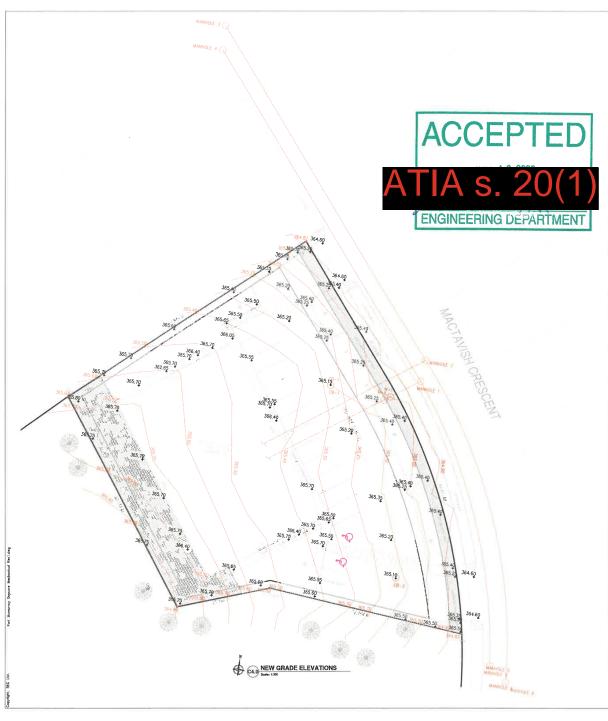

SITE SERVICING GENERAL NOTES:

- GENERAL CONTRACTOR SHALL USE THE SURVEY DRAWINGS
- General Cornination shall use the Sonney Dirammos for exact Dibersions and For Construction.

  MECHANICAL CONTRACTOR SHALL VERIFY ALL SITE UTILITIES AND REPORT DISCREPANICES BACK to THE ENGINEER OF RECORD PROB TO THE START OF CONSTRUCTION, DESIGNER DOSS NOT ACCEPT ANY LIBBILITY FOR EXISTING SITE. CONDITIONS.

  3. OWNER SHALL OBTAIN A LOT GRADING CERTIFICATE FROM

- CONDITIONS.

  OWNER SHALL OSTAIN A LOT GRADING CERTIFICATE FROM THE LAND SUPPOYER AT PROJECT COMPLETION FOR FINAL THE LAND SUPPOYER AT PROJECT COMPLETION FOR FINAL THE LAND SUPPOYER AT PROJECT COMPLETION FOR FINAL AND THE LAND SUPPOYER SU

MUNICIPAL ADDRESS 5028 MACTAVISH CRESCENT FORT MCMURRAY, ALBERTA (COUNTY OF WOOD BUFFALO)

LEGAL DESCRIPTION PLAN: 852 2444 CONDOMINIUM PLAN: 25735.

MANHOLES AND CATCHBASIN ELEVATIONS: INFORMATION FROM LNDT TECHNOLOGIES IN NOVEMBER 2021 MANHOLE 1: RIM ELEV: 364.99 N.INV: 360.85 S.INV: 360.83

MANHOLE 2: RIM ELEV: 364.93 N.INV: 360.10 S.INV: 360.08

MANHOLE 3: RIM ELEV: 364.61 N.INV: 360.75 S.INV: 360.72 E.INV: 360.79

MANHOLE 4: RIM ELEV: 364.70 N.INV: 361.07 S INV: 361.04 E.INV: 361.06

MANHOLE 5: RIM ELEV: 364.70 N.INV: 360.53 S.INV: 360.53 E.INV: 360.51 W.INV: 360.55

MANHOLE 6: RIM ELEV: 364.28 N.INV: 359.03 S.INV: 359.04 E.INV: 359.00 W.INV: 359.06

CATCH BASIN 1: RIM ELEVATION: 365.10

CATCH RASIN 2: RIM ELEVATION: 365.10

SAMPLING MANHOLE 1: RIM ELEVATION: 365.10

cr	VIL LEGEND:
Dis	stances are in meters and decimals thereof
Ele	evations are in meters and decimals thereo
Ma	inholes (
Fir	e hydrant 🔷
W	ater shut off valve 🖂
C:	tch basin
Ele	evations X
W	ater Line
Sa	nitary Line
Str	orm water Line
Gs	s Line
Ve	nt Line
Ch	eck Valve — —
В	ckwater Valve — BW
В	ackwater Valve]
U	nion or Flange
С	lean out
Н	ose bib/Non freeze hose bib
F	oor drain/ Roof drain







SEAL


PROJECT DAYCARE FACILITY 5028 MACTAVISH CRESCENT, FORT MCMURRAY, AB.


NEW GRADING PLAN Date MARCH 10, 2023 BEC-217 Scale 3" - 1"-0" A,G, M.K.

REV 2

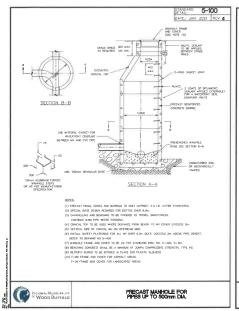


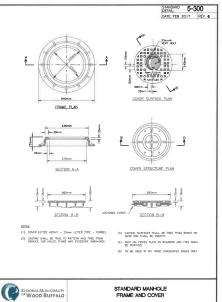


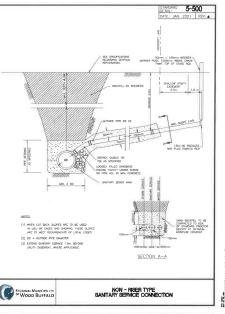


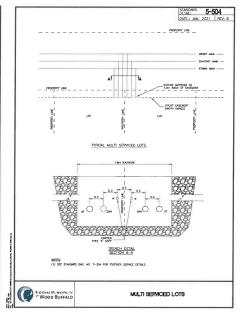



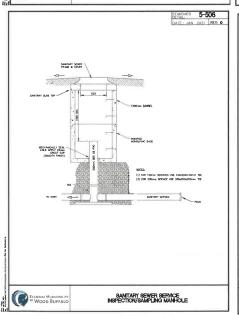

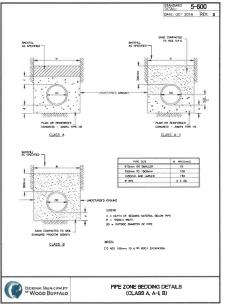

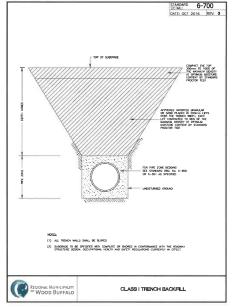





5028 MACTAVISH CRESCENT,

DAYCARE FACILITY

FORT MCMURRAY, AB.

Project number Scale 3" - 1"-0" A.G. REVISION REV 2

DRAWING TITLE

**SIDE VIEW** 

### SG1 NEW ILLUMINATED 3" CHANNEL LETTERS ON EXTERIOR WALL



(x1) NEW ILLUMINATED CHANNEL LETTERS

3" deep illuminated channel letters, 3" aluminum channel c/w white acrylic faces sheeted with day/night translucent vinyl, faces secured to channel with 1" trim. Illumination method - white LED's, thru wall wiring, power supply installed inside the building.

(x1) NEW ILLUMINATED SHAPED ILLUMINATED CAN


3" deep pan, 3" aluminum channel c/w white acrylic faces sheeted with translucent graphics, faces secured to channel with 1" trim. Illumination method - white LED's, thru wall wiring, power supply installed inside the building.



**DAYTIME VIEW** 



**NIGHTTIME VIEW** 

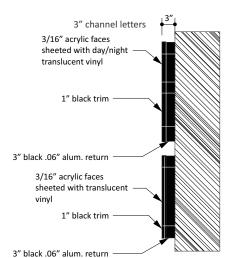





10214 Centennial Dr. Fort McMurray, AB, T9H 1Y5 P 587.536.6464 on-sitesign.com

W0 68924

Klorious Kids Ft. McMurray

CLIENT

**SALES** 

DATE July 16, 2025

14755-68924 J0 14755

**DESIGNER**: Casey

NOTES:

#### COLOUR DATA

WHITE ACRYLIC FACES

BLACK CHANNEL / BLACK TRIM

3M 3635-222 BLACK (dual colour vinyl) day copy black / night copy white

WHITE ACRYLIC FACES

BLACK CHANNEL / BLACK TRIM

DIGITALLY PRINTED TRANSLUCENT VINYL IJ3630-20 White Digital Media/ 8520 Matte Laminate





SCALE

NTS

Date:

Customer Signature:

Page 46

Plywood / OSB

Placement

#14x2" Unslotted Hex Head

with EPDM Bonded Washer

3"x1/4" LAG Screw



PAGE 2

**SIDE VIEW** 

# ONSITE SIGN

# SpeedPro Signs Graphics Solutions

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W0 68924

JOB Klorious Kids SITE Ft. McMurray

CLIENT


SALES

DATE July 16, 2025 FILE 14755-68924


14755

DESIGNER: Casey

NOTES:

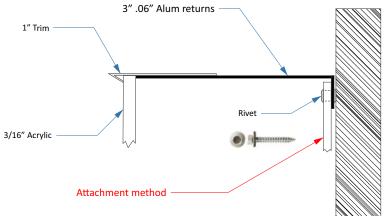

Wall Type	Fasteners	Min. QTY Fastener
	#14 Wood Screews (Prefered)	23
	#12 Wood Screews	25
1/2" Plywood	1/2" Female Liberty Anchors with Threaded Rod	10
	1/4" Lag Screw	11
	3/8" Lag Screw	21
	#14 Wood Screews (Prefered)	18
	#12 Wood Screews	16
3/4" Plywood	1/2" Female Liberty Anchors with Threaded Rod	18
	1/4" Lag Screw	10
	3/8" Lag Screw	10
1/2" OSB	#14 Wood Screews (Prefered)	15
1/2 038	#12 Wood Screews	13
Hollow Concrete Block	1/4" Tapcon screws (1" embedment) (Prefered)	41
Hollow College Ellock	HILTI HIT-HY 270 with Threaded Rod & Screen (2" embedment)	39
	1/4" Tapcon screws (1" embedment) (Prefered)	24
Precast or Reinforced Concrete	1/4" Tapcon screws (1½" embedment)	10
Frecast of Refinorced Concrete	3/8" HILTI Kwick Bolt TZ Expansion Anchor (2" embedment)	10
	HILTI HVU Capsule with 3/8" HAS Rod (3 1/2" embedment)	10
Single Wythe Brick	1/4" Buildex Tapcon (1" Embedment) (Min Space: 24"Vert., 16" Horiz.) (Prefered)	10
Siligle Wythe Blick	HILTI HIT-HY 270 w/ 3/8" Threaded Rod (6" embedment)	10
Thru Wall	1/4" ASTM A193 Gr B7	12
iiiiu vvaii	3/8" ASTM A193 Gr B7 (Prefered)	10
Aluminum Mullion 1/8" tk.	#12 Self Drilling Tech Screw	10
1/4" Tk. Steel	12-24 Pt. Type 5 Self Tapping Screw (Prefered)	10

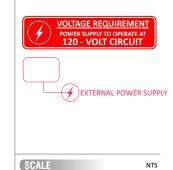

Date: Customer Signature:

**Wall Attachment Method** 

5/16" x 1-3/4" LTD

Concrete Anchor Hex Head

Concrete

Placement

All images, designs, concepts & content of this presentation are the property of Onsite Sign.



# Permanent Sign Review Form – Urban

Date	2024-07-24
Reviewer	Phyllis Agyemang
Permit Number	2025-DP-00235
Applicant/Contact	Debbie Hahn – Speed Pro

# **Required Documentation**

$\boxtimes$	Site Plan – indication of address, legal description of site area, and sign company information.
	<ul> <li>Must illustrate the exact location of the proposed sign with dimensions to at least two</li> </ul>
	(2) property lines.
	<ul> <li>Must illustrate the exact location of the proposed sign with dimensions to any other</li> </ul>
	signs on the property.
	<ul> <li>Illustrate all registered easements and right of ways on the subject property.</li> </ul>
$\boxtimes$	Signage Plan – signs shall be drafted to scale and must include the following:
	<ul> <li>Sign dimensions – including width and length, sign area used for advertising and any</li> </ul>
	changeable copy
	Total height of the sign
	Clearance height of the sign
$\boxtimes$	Building Elevations – elevation drawings showing the location of the sign. May not be
	applicable for portable signs.
$\boxtimes$	Certificate of Title – No more than 30 days old at time of application.
$\boxtimes$	Letter of Authorization – If Applicant is not the registered owner, a letter of authorization from
	the owner shall accompany the Certificate of Title

# **Subject Property Information**

Civic Address	120 McTavish Crescent
Legal Address	Plan 0220695, Unit 297
Zoning	Modified Manufactured Home District - RMH -1
Signage Type	Fascia Sign



## **Exemption Information**

A Development Permit is not required for the following signs provided that they otherwise comply with this By-law (Section 3.3.1)

- a. A-Board Signs
- b. Construction Site Identification Signs
- c. Display of Flags that are not commercial in nature
- d. Election Sign
- e. Identification Sign
- f. Incidental Sign
- g. Internal Sign
- h. Murals that do not include advertising
- i. Official Sign
- j. Poster Board Sign
- k. Private Sale Sign
- I. Real Estate Sale or Lease Sign and Real Estate Directional Sign
- m. Subdivision Directional Sign
- n. a Portable Sign placed by the Municipality
- o. a sign which is posted or exhibited inside a building other than a window sign
- p. a sign posted or exhibited in or on a motor vehicle, sea-can or trailer if the motor vehicle, sea-can or trailer is located on private land and not parked at the same approximate location for more than forty-eight (48) consecutive hours
- q. a Temporary Sign for a non-profit organization advertising an event that does not exceed 1.0 sq.m. provided that the sign is removed within forty-eight hours of the completion of the event to which the sign relates
- r. a Traffic or Directional Sign authorized by the Municipality or Alberta Transportation
- s. a sign posted or exhibited on a bus shelter or bench by the Municipality or Alberta Transportation
- t. a sign that is posted or exhibited solely for the identification of the land or building on a parcel including signs identifying the occupants, if the sign is:
  - i. less than 1.0 sq. m in area; and
  - ii. posted only at each public entrance provided from a road to the building
- u. a sign that is posted or exhibited for the sale, lease or rental of land or a building id the sign is:
  - i. 1.0 sq. m or less in area; and
  - ii. Posted on a side of a building or on a parcel, facing an adjacent road; or
- v. A change in the copy of a sign.

Is a development permit required?	☐ No, sign is exempt



## Fascia (Figure 6.6, 6.7 and 6.8)

Directions: Confirm that the application meets the requirements of the Land Use Bylaw. <u>Delete pages of the review form that do not apply to the sign being applied for.</u>

**Signage Information** 

- 8 - 8 -		
	Proposed Sign Dimensions	LUB Dimensions
Height		N/A
Width		N/A
Area	Sign Area=3.18m x 1.21m or 3.85m <sup>2</sup>	Maximum 25% of front façade of
	Which is less that 25% of the front	individual unit & 2.0m <sup>2</sup> for multi-
	façade.	residential units
Clearance	3.7m	Minimum 2.7 m
Projection	0.07	Maximum 0.3 m

Note: Fascia Sign Provisions Sec. 6.5, Page 44

**Eligibility and Design** 

Is the Fascia sign a permitted use? Sec. 8.3	□ yes	⊠ no
Is the Facia Sign for a multi-unit residential building? If yes, review (section 6.5.1b).	□ yes	⊠ no
Does the Facia Sign project more than 0.15m over a lane, loading area or parking lot? Sec. 6.5.4	□ yes	⊠ no
Does the Facia Sign have an electrical component and is located by a window? Sec. 6.5.5	□ yes	⊠ no
Is the frontage clearly defined or divided into separate units? Sec. 6.5.2c	⊠ yes	□ no
Does the Facia sign include any third-party advertising? Sec. 6.5.7	□yes	⊠ no
Is the Fascia sign an identification sign? Sec. 6.5.6	⊠ yes	□ no
Is the Fascia sign located on a building containing more than one commercial unit? Sec. 6.5.8	□ yes	⊠ no
Will the proposed Facia Sign be illuminated? Sec. 6.5.9	⊠ yes	□ no
Does the Facia Sign consist partially or entirely of a digital component? Sec. 6.5.10	□ yes	⊠ no
Is the proposed signage compliant with all Land Use Bylaw 99/059 provisions? Are revisions are required?	☐ Compliant	⊠ Non-compliant



Addit	tional Commen	ts:		
Dovio	wer Decision:			
Kevie	wei Decision.			
			ding decision, should be saved	to the property file,
digita	l and physical, an	d uploaded to Accela.		
Decision Date:		July 25, 2025	Advertising Date:	
Name / Position:		Phyllis Agyemang, Planner I		
	Decision			
	Approve			
	Reject			
Signs are not contemplated as permitted or discretionary uses in the RMH-1 District				
Addi	tional comments	and information:		